GENERAL NOTES:

- ALL WORK TO BE IN ACCORDANCE WITH ALBERTA BUILDING CODE 2006
- READTHE CONSTRUCTION DRAWINGS IN CONJUNCTION WITH THE ARCH., MECH., AND ELECT. DRAWINGS. REPORT ANY INCONSISTENCIES TO THE ENGINEER BEFORE PROCEEDING WITH THE WORK.
- FOR THE PURPOSES OF THESE DRAWINGS, THE ENGINEER IS KASSIAN DYCK AND ASSOCIATES.
- THE USE OF THESE DRAWINGS IS LIMITED TO THAT IDENTIFIED IN THE REVISIONS COLUMN. DO NOT CONSTRUCT FROM THESE DRAWINGS UNLESS MARKED "ISSUED FOR CONSTRUCTION" IN THE REVISIONS COLUMN BY KASSIAN DYCK & ASSOCIATES
- ALL EXISTING DIMENSIONS, ELEVATIONS, AND EXISTING STRUCTURAL SYSTEMS SHOWN ON THE STRUCTURAL DRAWINGS ARE TO BE VERIFIED ON SITE PRIOR TO CONSTRUCTION, AND DISCREPANCIES ARE TO BE REPORTED TO THE ENGINEER BEFORE PROCEEDING.
- ALL SECTIONS, DETAILS, AND STATEMENTS ARE TYPICAL AND APPLY TO ALL SIMILAR SITUATIONS IN THE STRUCTURE
- DRAWINGS SHOW COMPLETED STRUCTURES ONLY. THE DRAWINGS DO NOT SHOW COMPONENTS THAT MAY BE NECESSARY FOR CONSTRUCTION SAFETY. THE CONTRACTOR IS RESPONSIBLE FOR SAFETY IN AND ABOUT THE JOB SITE DURING CONSTRUCTION. THE CONTRACTOR IS TO DESIGN AND PROVIDE ALL TEMPORARY BRACING, SHORING, AND FORMWORK FOR CONSTRUCTION LOADING CARRIED OUT BY A PROFESSIONAL ENGINEER REGISTERED IN ALBERTA. CONSTRUCTION LOADS ON PERMANENT STRUCTURE SHALL NOT EXCEED DESIGN LOADS.
- FOR TEMPORARY SUPPORT OR STABILITY DURING STEEL ERECTION. CONTRACTOR TO PROVIDE AND INSTALL ALL NECESSARY TEMPORARY BRACING, SHORING AND SAFETY PROTECTION TO KEEP THE STRUCTURE SAFE, TRUE AND PLUMB. DO NOT REMOVE TEMPORARY BRACING UNTIL APPROVED IN WRITING BY KASSIAN DYCK & ASSOCIATES.
-). ALL TEMPORARY SAFETY GUARDS SHALL BE THE CONTRACTORS RESPONSIBILITY
- 1. SUBMIT TO THE ENGINEER FOR REVIEW 4 COPIES OF THE FOLLOWING SHOP DRAWINGS
- 12. SHOP DRAWINGS NOT STAMPED, SIGNED AND DATED WILL BE RETURNED WITHOUT BEING EXAMINED AND WILL BE CONSIDERED
- 13. FULLY DETAIL SHOP DRAWINGS AND SHOW ALL INFORMATION NECESSARY FOR FABRICATION AND INSTALLATION
- 14. DO NOT COMMENCE FABRICATION UNTIL REVIEW OF RETURNED SHOP DRAWINGS
- 5. REVIEW OF SHOP DRAWINGS DOES NOT RELIEVE THE CONTRACTOR FROM COMPLIANCE WITH THE CONTRACT DOCUMENTS. THE REVIEW 27. SLAB ON GRADE WILL SHRINK AND SETTLE DUE TO BACKFILL DEPTH AND EXISTING SOIL CONDITIONS. MINOR CRACKING OF SLAB ON OF SHOP DRAWINGS BY THE ENGINEER IS FOR THE SOLE PURPOSE OF ASCERTAINING CONFORMANCE WITH THE GENERAL STRUCTURAL DESIGN CONCEPT AND THE EXTENT OF THIS REVIEW IS AT THE SOLE DISCRETION OF THE ENGINEER. THIS REVIEW IS NOT AN APPROVAL OF THE DESIGN, DETAILS AND DIMENSIONS INHERENT IN THE SHOP DRAWINGS. THIS REVIEW DOES NOT MEAN THAT THE ENGINEER APPROVES THE DESIGN OR DETAILS INHERENT IN THE SHOP DRAWINGS. THE RESPONSIBILITY FOR WHICH REMAINS WITH THE CONTRACTOR. REVIEW OF SHOP DRAWINGS DOES NOT RELIEVE THE CONTRACTOR OF HIS OR HER RESPONSIBILITY FOR MEETING ALL REQUIREMENTS OF THE CONTRACT DO CUMENTS. THE CONTRACTOR IS RESPONSIBLE FOR DIMENSIONS TO BE CONFIRMED AND COORDINATED AT THE JOB SITE, FABRICATION PROCESSES, TECHNIQUES OF CONSTRUCTION AND INSTALLATION, AND FOR COORDINATION
- 3. THE CONTRACTOR SHALL EXAMINE THE SITE AND THE SUBSURFACE INVESTIGATION REPORT AND A CCEPT ALL CHARACTERISTICS AND IRREGULARITIES OF THIS SITE

7. DESIGN LOADS

SPECIFIED UNIFORM LOADS:
SUPERIMPOSED DEAD LOAD (SDL-EXCLUDES SELF WEIGHT OF ROOF/FLOOR STRUCTURE) LIVE LOAD (LL) SNOWLOAD(SL)

MAIN FLOOR: SDL = 0.72 KPA; LL = 4.8 KPA

ROOF

SELSMIC:

DL = 1.65 KPA, SL = 1.8 kPa (38 PSF) + DRIFT AS NOTED ON PLAN PONDING AS NOTED ON PLAN LL = 1.0 KPA (21 PSF)

SPECIFIED CONCENTRATED LIVE LOADS:

2 KN AT A NY JOIST PANEL POINT

Sa(0.2) = 0.12 Sa(0.5) = 0.06 Sa(1.0) = 0.02 Sa(2.0) = 0.01 PGA = 0.06 SITE CLASS C

SEISMIC LOAD RESISTING SYSTEM IS A CONVENTIONAL CONSTRUCTION BRACED FRAME WITH

q50 = 0.40 kPa (8 PSF) WIND: NET FACTORED WIND UPLIFT LOADS ON ROOFS = 1.0 kPa (21 PSF) UNLESS NOTED OTHERWISE

GENERAL NOTES (cont.)

18. STRUCTURE WILL MOVE DUE TO IMPOSED LOADS, SHRINKAGE THERMAL EFFECTS, AND/OR FOUNDATION SETTLEMENT. THE FOLLOWING ESTIMATED MOVEMENTS ARE TO BE ACCOMMODATED BY NON-STRUCTURAL ELEMENTS ATTACHED TO STRUCTURE... DESIGN AND DETAILING OF NON-STRUCTURAL ELEMENTS TO BE BY OTHERS.

2. CEMENT: NORMAL PORTLAND CEMENT TO CAN/CSA-A5, TYPE GU OR SULPHAT

- MOVEMENT AT EXPANSION JOINTS: - VERTICAL

- PERPENDICULAR TO JOINT - PARALLEL TO JOINT

- HORIZONTAL DRIFT DURING WIND AND SEISMIC BETWEEN FLOORS.

- ± 13 mm WITHOUT DAMAGE TO NON-STRUCTURAL ELEMENTS ± 50 mm WITHOUT COLLAPSE OF NON-STRUCTURAL ELEMENTS
- DIFFERENTIAL VERTICAL MOVEMENT OF ADJACENT COLUMNS AND WALLS: 15 mm
- 19. CONTRACTOR'S CONSTRUCTION LOADS MUST NOT EXCEED THE ABOVE DESIGN LOADS. DESIGN LOADS MAY ONLY BE APPLIED AFTER THE
- 20. UNDERPIN WHERE NECESSARY ANY EXISTING STRUCTURE AND PROVIDE A.L. BRACING, SHORING, ETC. TO SUPPORT ADJOINING SOIL, FLOORS, WALLS, ETC. AS REQUIRED TO RETAIN ALL WORK IN FLACE AND PREVENT ANY OVERSTRESSING OF THE STRUCTURE.
- CONDITIONS AND THE STABILITY OF THE STRUCTURE DURING CONSTRUCTION, DESIGN OF SHORING AND TEMPORARY BRACING SHALL BE 21. THE CONTRACTOR SHALL CO-OPERATE WITH ALL TESTING, INSPECTION, AND QUALITY CONTROL PERSONNEL REQUIRED ON THE SITE AND WILL PROVIDE CASUAL LABOUR FORCES AS REQUIRED TO ASSIST IN ALL THE FIELD REVEW PROCEDURES. THE CONTRACTOR SHALL GIVE REASONABLE NOTICE TO THESE AGENCIES PRIOR TO REQUIRING THEIR SERVICES.
- ANCHOR BOLTS HAVE BEEN DESIGNED FOR LOADS OF THE COMPLETED STRUCTURE ONLY AND ARE NOT TO BE USED OR RELIED UPON 22. THE ENGINEER OR HIS REPRESENTATIVE WILL PROVIDE PERICDIC SITE REVIEWS FOR WORK SHOWN ON THESE DRAWINGS TO ASCERTAIN 5. CALCIUM CHLORIDE SHALL NOT BE USED AS ADMIXTURE. WHETHER THE STRUCTURAL WORK IS IN GENERAL CONFORMINGE WITH THE CONTRACT DOCUMENTS. THE SITE REVIEWS ARE NOT FOR THE CONTRACTOR'S BENEFIT AND THE CONTRACTOR REMAINS FULLY RESPONSIBLE TO ENSURE THAT ALL STRUCTURAL WORK IS CARRIED 0.01T IN ACCORDANCE WITH THESE DRAWINGS AND ALL APPLICABLE CODES. THE WORK TO BE REVIEWED SHALL GENERALLY BE
 - 23. PROVIDE 48 HOURS ADVANCE NOTICE OF EACH REQUIRED SITE REVIEW. SITE REVIEWS SHALL BE SCHEDULED TO BE CARRIED OUT DURING NORMAL BUSINESS HOURS UNLESS SPECIAL ARRANGEMENTS AREMADE WITH KASSIAN DYCK & ASSOCIATES
 - 24. PROVIDE 48 HRS. NOTICE PRIOR TO POURING CONCRETE. ALL REINFORCEMENT SHALL BE IN PLACE AND SECURED AT THE TIME OF THE REVIEW. REINFORCEMENT SHALL BE REVIEWED IN PLACE BY A REPRESENTATIVE OF THE ENGINEER, PRIOR TO PLACING CONCRETE.
 - 25. BEFORE CONCEALING ANY STRUCTURAL ELEMENTS, PROVIDEMINIMJM 48 HRS. NOTICE TO ENGINEER SO THE STRUCTURE CAN BE INSPECTED BY A REPRESENTATIVE OF THE ENGINEER.
 - 26. DO NOT CUT OR DRILL ANY OPENINGS INTO STRUCTURAL MEMBERS WITHOUT OBTAINING WRITTEN APPROVAL FROM KASSIAN DYCK &

FOUNDATION NOTES:

- 1. FOUNDATION DESIGN TO BE IN ACCORDANCE WITH THE GEOTECHNICAL INVESTIGATION REPORT
- UNLESS NOTED OTHERWISE FOUNDATION WALLS ARE NOT DESIGNED AS CANTILEVER WALLS. WALLS SHALL BE BACKFILLED EVENLY ON BOTH SIDES TO PREVENT LATERAL MOVEMENT. BACKFILL HEIGHTS SHALL NOT VARY BY MORE THAN 300 mm (12 INCH) FROM ONE SIDE TO THE OTHER.
- 3. DO NOT LOCATE UNDERGROUND SERVICES OR PIPING ADJACENT TO OR BELOW FOOTINGS WITHIN A 45 DEGREE SLOPE LINE EXTENDING DOWNFROM THE EDGE OF ALL FOOTINGS.
- 4. UNDERPIN WHERE NECESSARY ANY EXISTING STRUCTURE AND PROVIDE ALL BRACING AND SHORING TO SUPPORT ADJOINING SOIL, FLOORS, WALLS, ETC. AS REQUIRED TO RETAIN ALL WORK IN PLACE AND PREVENT ANY OVERSTRESSING OF THE STRUCTURE. THE CONTRACTOR SHALL BE RESPONSIBLE FOR THE DESIGN OF ALL TEMPORARY UNDERPINNING, SHORING BRACING, AND SHALL SUBMIT 4 COPIES OF DRAWINGS SEALED BY A PROFESSIONAL ENGINEER REGISTERED IN ALBERTA.
- 5. REFER TO ARCHITECTURAL DRAWINGS AND SPECIFICATIONS FOR DAMPROOFING OR WATERPROOFING REQUIREMENTS.

SLAB-ON-GRADE NOTES:

PERMIT TO PRACTICE NUMBER: P 5820

- 1. PLACE CONCRETE TO CAN/CSA-A23.1.
- VIBRATE ALL CONCRETE.
- 3. SAWCUT SLABS ON GRADE WITHIN 16 HOURS AFTER PLACING CONCRETE. SAW CUT NOT LESS THAN 35 mm (1 3/8 INCH) DEEP
- 4. SAWCUT INTERIOR SLABS ON GRADE INTO PANELS NOT EXCEEDING 21 SQUARE METRES WITH A MAXIMUM PANEL DIMENSION OF
- 5. REMOVE ALL DEBRIS FROM SAWCUTS/CONTROL JOINTS. FILL SAWCUTS/CONTROL JOINTS SMOOTH AND LEVEL USING BACKING
- 6. PLACE EDGE JOINT FILLER AT SLAB EDGES AT WALLS AND GRADE BEAMS. LEAVE 13 mm (1/2 INCH) DEEP RECESS AND FILL JOINT WITH CONTROL JOINT SEALANT.
- 7. CURE HORIZONTAL SURFACES BY KEEPING THEM WET FOR 7DAYS, BY COVERING WITH A POLYETHYLENE SHEET WELL LAPPED AND EDGES WEIGHTED, OR WITH AN APPROVED CURING AGENT.


CONCRETE NOTES

- 2. CEMENT: NORMAL PORTLAND CEMENT TO CAN/CSA-A5, TYPE GUIOR SULPHATE RESISTANT CEMENT TO CAN/CSA-A5 TYPE HS
- 3. CONCRETE TO BE IN ACCORDANCE WITH FOLLOWING PERFORMANCE SCHEDULE. RESPONSIBILITIES OF OWNER, CONTRACTOR AND SUPPLIER ARE IN ACCORDANCE WITH ALTERNATIVE 1, TABLE 5 OR CSA A23.1-04.

LOCATION	STRENGTH	EXPOSURE	AIR	MAX AGGREG.	MAX W/C
FOOTINGS, EXTERIOR	25 MPa 3600 psi	F-2	4-7%	40 mm 1½ INCH	0.55
FOOTINGS, INTERIOR	25 MPa 3600 psi	N	0	40 mm 1½ INCH	0.55
FOUNDATION BASEMENT WALLS	25 MPa 3600 psi	F-2	4-7%	20 mm 3/4 INCH	0.55
SLAB ON GRADE, INTERIOR	25 MPa 3600 psi	N	0	20 mm 3/4 INCH	0.50
SLAB ON GRADE, EXTERIOR	32 MPa 4600 psi	C2	5-8%	20 mm 3/4 INCH	0.45

- 4. AIR ENTRAINING ADMIXTURE TO ASTM C 260
- CONTRACTOR TO PREPARE AND IMPLEMENT CUALITY CONTROL PLAN TO ENSURE THAT CONCRETE PERFORMANCE CRITERIA WILL BE MET, AND SUBMIT DOCUMENTATION DEMONSTRATING THAT PERFORMANCE REQUIREMENTS HAVE BEEN MET.
- PERFORM AT LEAST ONE CONCRETE TEST (3 CYLINDERS) FOR EACH 50 CUBIC METRES OF CONCRETE, OR FRACTION THEREOF, OF EACH TYPE OF CONCRETE POURED IN ANY ONE DAY.
- 8. CONTRACTOR TO CALL FOR CONCRETE TESTING AT AFPROPRIATE TIME
- VOID FCRM: EXPANDED POLYSTYRENE CONFIGURED TO SUPPORT A MAXIMUM LOAD OF 27 kPa (560 psi) AT 5 % DEFORMATION AND 50 kPa AT 40% DEFORMATION FROST CUSHION BY BEAVER PLASTICS OR APPROVEDE QUAL. PROVIDE 100 mm(4 INCH) THICK NESS UNLESS NOTED OTHERWISE
- 10. EDGE JOINT FILLER: BITUMINOUS IMPREGNATED FIBREBOARD, 12 mm (1/2 INCH) THICK, TO ASTM D1751-83.
- 11. WATERSTOP: RX WATERSTOP AS MANUFACTURED BY AMERICAN COLLOID COMPANY, OR APPROVED EQUAL
- 12. DRY PACK GROUT: NON-METALLIC, NON-SHRINK, CEMENTITIOUS GROUT, WITH MINIMUM 28 DAY STRENGTHOF 25 MPa (3600 psi).
- 13. PLACE CONCRETE AS CLOSE AS POSSIBLE TO FINAL LOCATION TO AVOID SEGREGATION. VIBRATE ALL CONCRETE
- 14. BRING ALL FLOORS TO AN EVEN, LEVEL, OR SLOPING SURFACE AS INDICATED ON THE DRAWINGS, READY TO RECEIVE THE
- 15. UNLESS NOTED OTHERWISE PROVIDE THE FOLLOWING FINISHES TO CONCRETE FLOORS:

 - INTERIOR FLOORS STEEL TROWEL EXTERIOR SIDEWALKS AND SLABS BROOM FINISH INTERIOR PARKING SLABS AND RAMPS POWER FLOAT FINISH
 - DO NOT OVERWORK SLAB SURFACE; FLOOR TO BE LEVEL WITHIN 3 mm (1/8 INCH) IN 3000 mm (10 FT).
- 16. MINIMUM CONCRETE THICKNESS FOR SIDEWALKS AND RAMPS IS 100 mm (4 INCH) UNLESS NOTED OTHERWISE
- 17. PROVIDE CONTROL JOINTS IN FOUNDATION/BASEMENT WALLS AT 6 m (20 FT) O/C MAXIMUM. SEE TYPICAL DETAILS.
- 18. PROVIDE TOOLED JOINTS IN SIDEWALKS AT 1200 mm (4 FT) O/C MAXIMUM
- 19. SUBMITLOCATIONS OF ALL CONSTRUCTION JOINTS TO ENGINEER FOR APPROVAL
- 20. PROTECT CONCRETE FROM FREEZING. DO NOT PLACE CONCRETE AGAINST FROZEN GROUND. USE WINTER CONCRETING METHODS IN ACCORDANCE WITH CSA A23.1-04.
- 21. PROTECT CONCRETE FROM EXCESSIVE HEAT AND DRYING. USE HOT WEATHER CONCRETING METHODS IN ACCORDANCE WITH
- 22. CURE CONCRETE IN ACCORDANCE WITH A23.1-04, AND FORA MINIMUM OF 7 DAYS AT A MINIMUM TEMPERATURE OF 10 DEGREES C. OR FOR THE TIME NECESSARY TO OBTAIN 70% OF THE SPECIFIED 28 DAY COMPRESSIVE STRENGTH.
- 23. PARGE EXPOSED FOUNDATION WALL AND REINFORCE WITH MESH. APPLY BONDING AGENT.

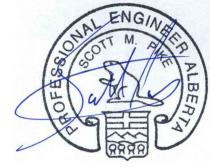

AUGUST 18, 2014 PERMIT NO. P5820

ISSUED FOR BUILDING PERMIT 08-18-14 NO. REVISION DATE

KASSIAN DYCK AND ASSOCIATES IS A DIVISION OF 594798 ALBERTA LTD. THIS IS A COPYRIGHT DRAWING AND DESIGN, AND SHALL NOT BE USED OR

- REPRODUCED WITHOUT WRITTEN APPROVAL OF KASSIAN DYCK AND ASSOCIATES. THE CONTRACTOR SHALL CHECK AND VERIFY ALL DIMENSIONS AND REPORT
- ALL ERRORS AND OMISSIONS PRIOR TO COMMENCING WORK.
- THESE DRAWINGS ARE NOT TO BE SCALED.



1475, 10655 SOUTHPORT ROAD S.W. CALGARY, ALBERTA, CANADA T2W 4Y1 FAX (403) 255-6043

SHOPPING CENTRE 2119 50TH AVE, RED DEER AB					
DWG. TITLE		GENERAL	NOTES		
DRAWN RB	ENG.	SP		DWG No.	REV.
DATE 2014-08-18	SCALE	AS NOTED	1 10 10	S1.0	

CONCRETE REINFORCEMENT NOTES

- ALL WORK TO BE IN ACCORDANCE WITH CSA A23.1-04 AND A23.3-04.
- REINFORCING BARS: DEFORMED BARS, GRADE 400 CONFORMING TO CSA G30.18 UNLESS NOTED OTHERWISE.
- WELDED WIRE FABRIC: GRADE 400 CONFORMING TO CSA G30.5. PROVIDE IN FLAT SHEETS ONLY.
- SHOP DRAWINGS SHALL INCLUDE BENDING, CUTTING, AND PLACING DRAWINGS FOR ALL REINFORCING STEEL. CLEARLY INDICATE CONCRETE COVER TO REINFORCING, BAR SIZES, GRADES, SPACING, REINFORCEMENT LOCATIONS, AND BAR SUPPORTS.
- PROVIDE CLASS B SPLICES FOR ALL REINFORCEMENT UNLESS SHOWN OTHERWISE (600 mm (2 FT) MN).
- PROVIDE ADDITIONAL SUPPORT BARS AS REQUIRED TO ADEQUATELY SUPPORT AND SECURE ALL REINFORCEMENT AND PREVENT MOVEMENT WHEN PLACING CONCRETE. PROVIDE AS A MINIMUM THE FOLLOWING:
 - 10M U BAR SPACERS AT 3 m (10 FT) O/C HORIZONTALLY AND 1.5 m (5 FT) O/C VERTICALLY TO HOLD WALL REINFORCING MATS IN 6.
 - 10M UBAR SPACERS AT 3 m (10 F) DUC HOVIZON INCLE AND 10 H (2 FT) O/C FOR 10M BARS, AND 1200 mm (4 FT) O/C FOR 15M AND LARGER BARS
 15M SUPPORT BARS AT A MAXIMUM OF 1200 mm (4FT) O/C SPACING IN EACH DIRECTION FOR BOTTOM REINFORCING
 15 M SUPPORT BARS AT A MAXIMUM OF 1200 mm (4FT) O/C SPACING IN EACH DIRECTION FOR BOTTOM REINFORCING
 15 M SUPPORT BARS IN HOOKS AND EACH CORNER OF ST RRUPS UNLESS SHOWN OTHERWISE

- LOCATE CHAIRS FOR REINFORCING AT A MAXIMUM OF 1200 mm (4 FT) CENTRES.
- PROVIDE 15M X 1500 mm LONG DOWELS TO ALL REINFORCED MASONRY WALLS OR COLUMNS. NUMBER TO MATCH COLUMN OR WALL
- UNLESS OTHERWISE SHOWN, CLEAR CONCRETE COVER TO REINFORCEMENT TO BE AS FOLLOWS:

SLABS, WALLS, JOISTS, 20M & SMALLER, EXPOSED	40 mm	(1-5/8 INCH)
SLABS, WALLS, JOISTS, 20M & SMALLER, NOT EXPOSED, UP TO 2 HRS FIRE RATING	25 mm	(1 INCH)
SLABS, WALLS, JOISTS, 20M & SMALLER, NOT EXPOSED, UP TO 3 HRS FIRE RATING	35 mm	(1-3/8 INCH)
PARKING SLABS, TOP	40 mm	(1-5/8 INCH)
PARKING SLABS, BOTTOM	30 mm	(1-1/4 INCH)
CONCRETE POURED AGAINST EARTH	75 mm	(31NCH)
SLABS POURED AGAINST VOID FORM	50 mm	(21NCH)
COLUMN TIES, BEAM STIRRUPS	40 mm	(1-5/8 INCH)
BEAMS & COLUMNS, PRINCIPAL REINF., 35M & SMALLER, EXPOSED	50 mm	(21NCH)
BEAMS & COLUMNS, PRINCIPAL REINF., 35M & SMALLER, NOT EXPOSED	40 mm	(1-5/8 INCH)
BARS LARGER THAIN THOSE LISTED ABOVE, EXPOSED	1.5 x DI A	AM.
BARS LARGER THAN THOSE LISTED ABOVE, NOT EXPOSED	1.0 x DIA	AM.

EXPOSED MEANS EXPOSURE TO EARTH AND/OR WEATHER

- ENSURE REINFORCING IS CLEAN; FREE OF LOOSE SCALE, OIL, DIRT, RUST, AND ANY OTHER FOREIGN COATINGS THAT AFFECT BONDING
- UNLESS NOTED OTHERWISE, ALL REBAR EMBEDMENT AND LAP SPLICE LENGTHS TO BE AS SHOWN IN FOLLOWING TABLE. ALL TENSION LAP SPLICES ARE CLASS B. WHERE NO EMBEDMENT TYPE IS INDICATED, PROVIDE TENSION EMBEDMENT. WHERE NO LAP SPLICE TYPE IS INDICATED, PROVIDE TENSION LAP SPLICE.

TENSION DEVELOPMENT (EMBEDMENT) LENGTHS / LAP SPLICE LENGTHS (mm)

BAR SIZE	CONCRETE STRENGTH								
	20 MPa			25 MPa		30 MPa		35 MPa	
	EMBE D.	LAP	EMBED	LAP	ENBED	LAP	EMBED	LAP	
10M	320	420	300	390	300	390	300	390	
15M	480	630	430	560	390	510	370	480	
20M	640	840	580	750	530	680	490	630	
25M	1010	1310	900	1170	820	1070	760	990	
30M	1210	1570	10 80	1400	990	1280	910	1190	
35M	1410	1830	1200	1640	1150	1500	1070	1380	

NOTES: - ALL TOP BAR SPLICES AND EMBEDMENT LENGTHS TO BE 1.3 TIMES LONGER THAN VALUES SHOWN ABOVE.

- TOP BARS ARE THOSE WHICH ARE CAST WITH 300 mm OR MORE CONCRETE BELOW BAR. STIRRUP SPLICES NOT ALLOWED EXCEPT WHEN APPROVED BY ENGINEER
- SPLICES FOR EPOXY COATED REINFORCEMENT TO BE INCREASED AS PER ENGINEERS INSTRUCTIONS.

COMPRESSION LAPSPLICE LENGTHS (mm)

BAR SIZE	LAP
10M	300
15M	440
20M	580
25M	730
30M	880
35M	1020

EXCAVATION AND BACKFILL NOTES:

- 1. ALL EARTHWORK INCLUDING EXCAVATION AND BACKFILL TO BE DONE IN ACCORDANCE WITH SOILS REPORT
- 2. LOCATE ALL UNDERGROUND SERVICES PRIOR TO EXCAVATING OR DRILLING.
- 3. STRIP ALL TOPSOIL, FILL, FROZEN SOIL, WET AND/OR WEAK SOILS, AND DEBRIS FROM THE BUILDING AREA.
- EXCAVATE TO ELEVATIONS SHOWN.
- 5. TEMPORARY SLOPES FOR EXCAVATIONS NOT TO EXCEED 1 HORIZ. TO 1 VERT. IN CLAY, OR 2 HORIZ. TO 1 VERT. IN SAND. PROVIDE SHALLOWER SLOPES AS REQUIRED BY SOIL CONDITIONS.
- PRIOR TO PLACING FILL BELOW SLABS ON GRADE OR ASPHALT PAVING, PROOF ROLL THE SUBGRADE, REMOVE ANY SOFT AREAS AND REPLACE WITH COMPACTED PIT RUN GRAVEL, AND COMPACT EXISTING SUBGRADE TO OBTAIN THE SAME COMPACTION AS SPECIFIED FOR THE FILL.
- 7. PIT RUN GRAVEL TO BE WELL GRADED, 100 mm (4 INCH) MINUS.
- 8. CRUSHED GRAVEL TO BE 20 mm (3/4 INCH) ROAD CRUSH.
- 9. BACKFILL AND FILL TO BE AS FOLLOWS:
 - CRUSHED GRAVEL BELOW SLAB ON GRADE
 - APPROVED NATIVE SOIL BELOW LANDSCAPED AREAS
- 10. COMPACT ALL BACKFILL BELOW SLABS ON GRADE, ASPHALT PAVING, AND STRUCTURAL SLABS TO 98% STANDARD PROCTOR MAXIMUM DRY DENSITY. COMPACT ALL BACKFILL BELOW LANDSCAPED AREAS TO 95% STANDARD PROCTOR MAXIMUM DRY DENSITY. COMPACT IN MAXIMUM 150 mm (6 INCH) LIFTS.
- 11. UNLESS NOTED OTHERWISE, FOUNDATIONS AND WALLS SHALL BE EACKFILLED EVENLY ON BOTH SIDES TO PREVENT LATERAL MOVEMENT. BACKFILL HEIGHTS SHALL NOT VARY BY MORE THAN 300 mm (12 INCH) FROM ONE SIDE TO THE OTHER. EXERCISE EXTREME CAUTION DURING BACKFILL OPERATIONS TO PREVENT DAMAGE TO THE CONCRETE. DO NOT BACKFILL BASEMENT WALLS UNTIL BASEMENT SLAB ON GRADE AND MAIN FLOOR FRAMING (C/W BLOCKING) IS IN PLACE AND IS PROVIDING PROPER
- 12. ALL SURFACE GRADING ADJACENT TO THE BUILDING SHALL BE SLOPED AWAY FROM THE STRUCTURE (ALLOW EXTRA SOIL TO ACCOUNT FOR SEASONAL SETTLEMENT).
- 13. DO NOT ENCROACH A 45-DEGREE ANGLE OF BEARING FROM ADJACENT FOOTING BOTTOMS U.N.O.
- 14. KEEP EXCAVATION DRAINED AND FREE OF WATER AT ALL TIMES.
- 15. TAKE ALL NECESSARY MEASURES AND PRECAUTIONS TO PREVENT FREEZING OF SOILS BELOW FOOTINGS AND INTERIOR SLABS
- 16. REMOVE FROM SITE AND DISPOSE OF ANY SURPLUS MATERIAL.



PERMIT NO. P5820

А	ISSUED FOR BUILDING PERMIT	08-18-14
NO.	REVISION	DATE

KASSIAN DYCK AND ASSOCIATES IS A DIVISION OF 594798 ALBERTA LTD.


- THIS IS A COPYRIGHT DRAWING AND DESIGN. AND SHALL NOT BE USED OR
- REPRODUCED WITHOUT WRITTEN APPROVAL OF KASSIAN DYCK AND ASSOCIATES. THE CONTRACTOR SHALL CHECK AND VERIFY ALL DIMENSIONS AND REPORT
- ALL ERRORS AND OMISSIONS PRIOR TO COMMENCING WORK.
- THESE DRAWINGS ARE NOT TO BE SCALED.




1475, 10655 SOUTHPORT ROAD S.W. PHONE (403) 255-6040 CALGARY, ALBERTA, CANADA T2W 4Y1 FAX (403) 255-6043


ROJECT	SHOPPING CENTRE 2119 50TH AVE, RED DEER AB				
WG. TITLE	GENERAL	NOTES			
RAWN RB	ENG. SP	PROJ. No. 14046	DWG No.	REV.	
^{ATE} 2014-08-18	scale as noted		S0.2		

PERMIT TO PRACTICE NUMBER: P 5820

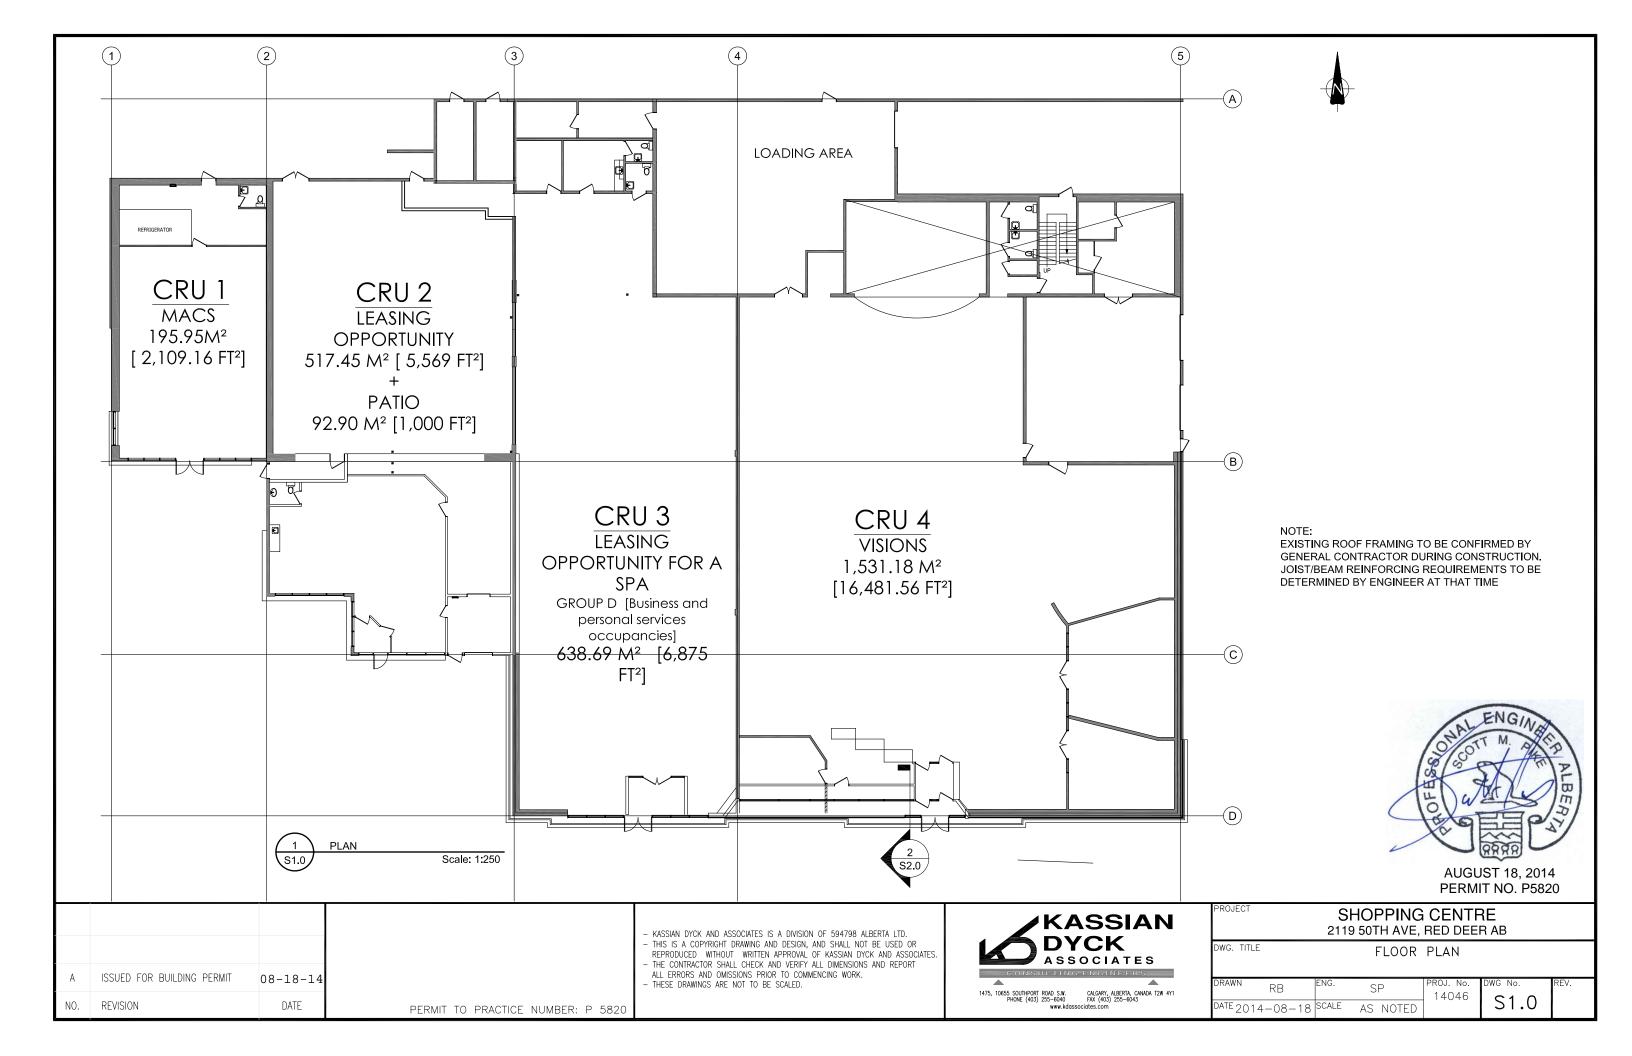

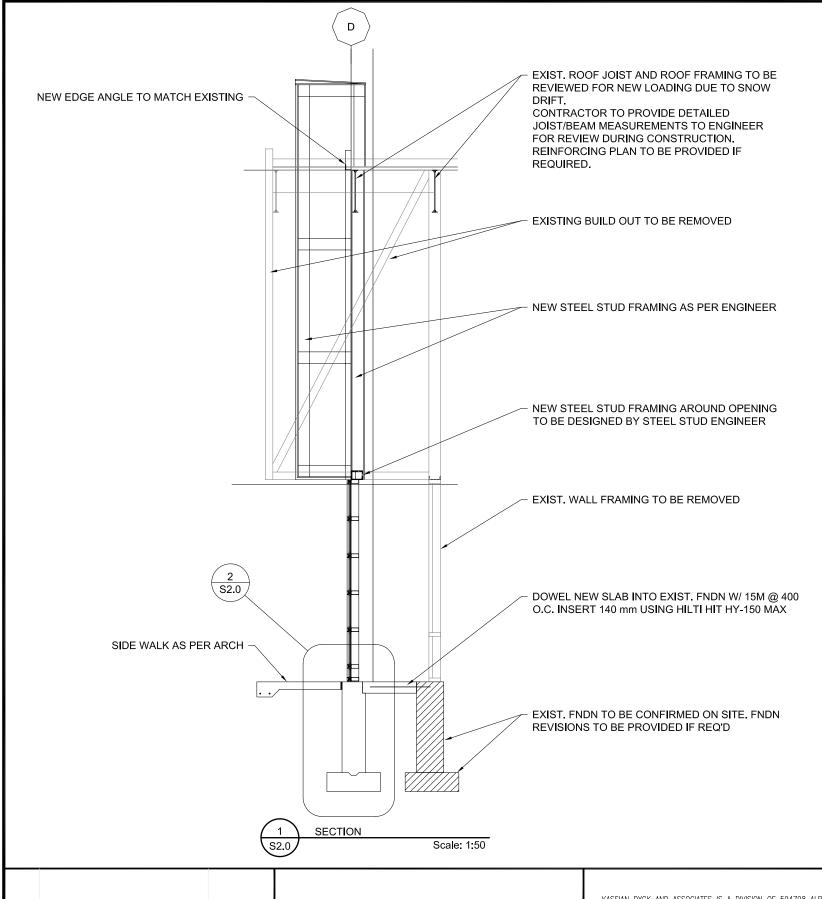

PERMIT TO PRACTICE NUMBER: P 5820

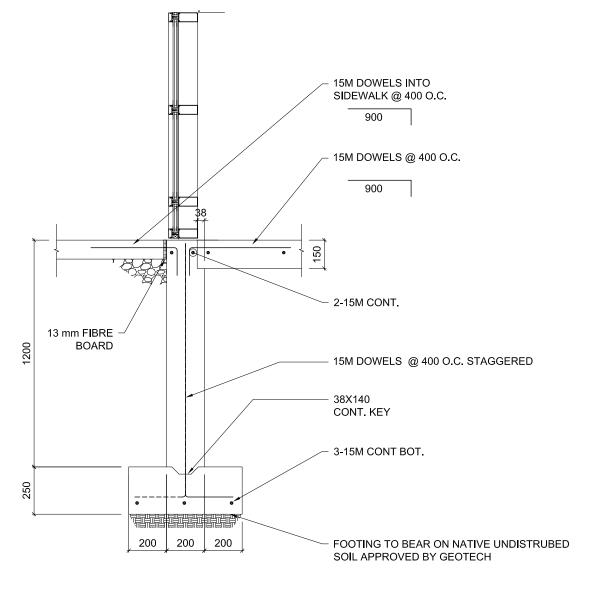

2 DETIL S2.0 Scale: 1:50



AUGUST 18, 2014 PERMIT NO. P5820

А	ISSUED FOR BUILDING PERMIT	08-18-14
NO.	REVISION	DATE

- KASSIAN DYCK AND ASSOCIATES IS A DIVISION OF 594798 ALBERTA LTD. - THIS IS A COPYRIGHT DRAWING AND DESIGN, AND SHALL NOT BE USED OR

REPRODUCED WITHOUT WRITTEN APPROVAL OF KASSIAN DYCK AND ASSOCIATES.

- THE CONTRACTOR SHALL CHECK AND VERIFY ALL DIMENSIONS AND REPORT
ALL ERRORS AND OMISSIONS PRIOR TO COMMENCING WORK.


- THESE DRAWINGS ARE NOT TO BE SCALED.

1475, 10655 SOUTHPORT ROAD S.W. CALGARY, ALBERTA, CANADA T2W 4Y1 PHONE (403) 255–6040 FAX (403) 255–6043 www.kdassociates.com

KASSIAN

SHOPPING CENTRE 2119 50TH AVE, RED DEER AB						
DWG. TITLE			SECTION 8	k DETAIL		
DRAWN	RB	ENG.	SP	PROJ. No. 14046	DWG No.	REV.
DATE 2014	1-08-18	SCALE	AS NOTED		S2.0	

LANDSCAPED LANE

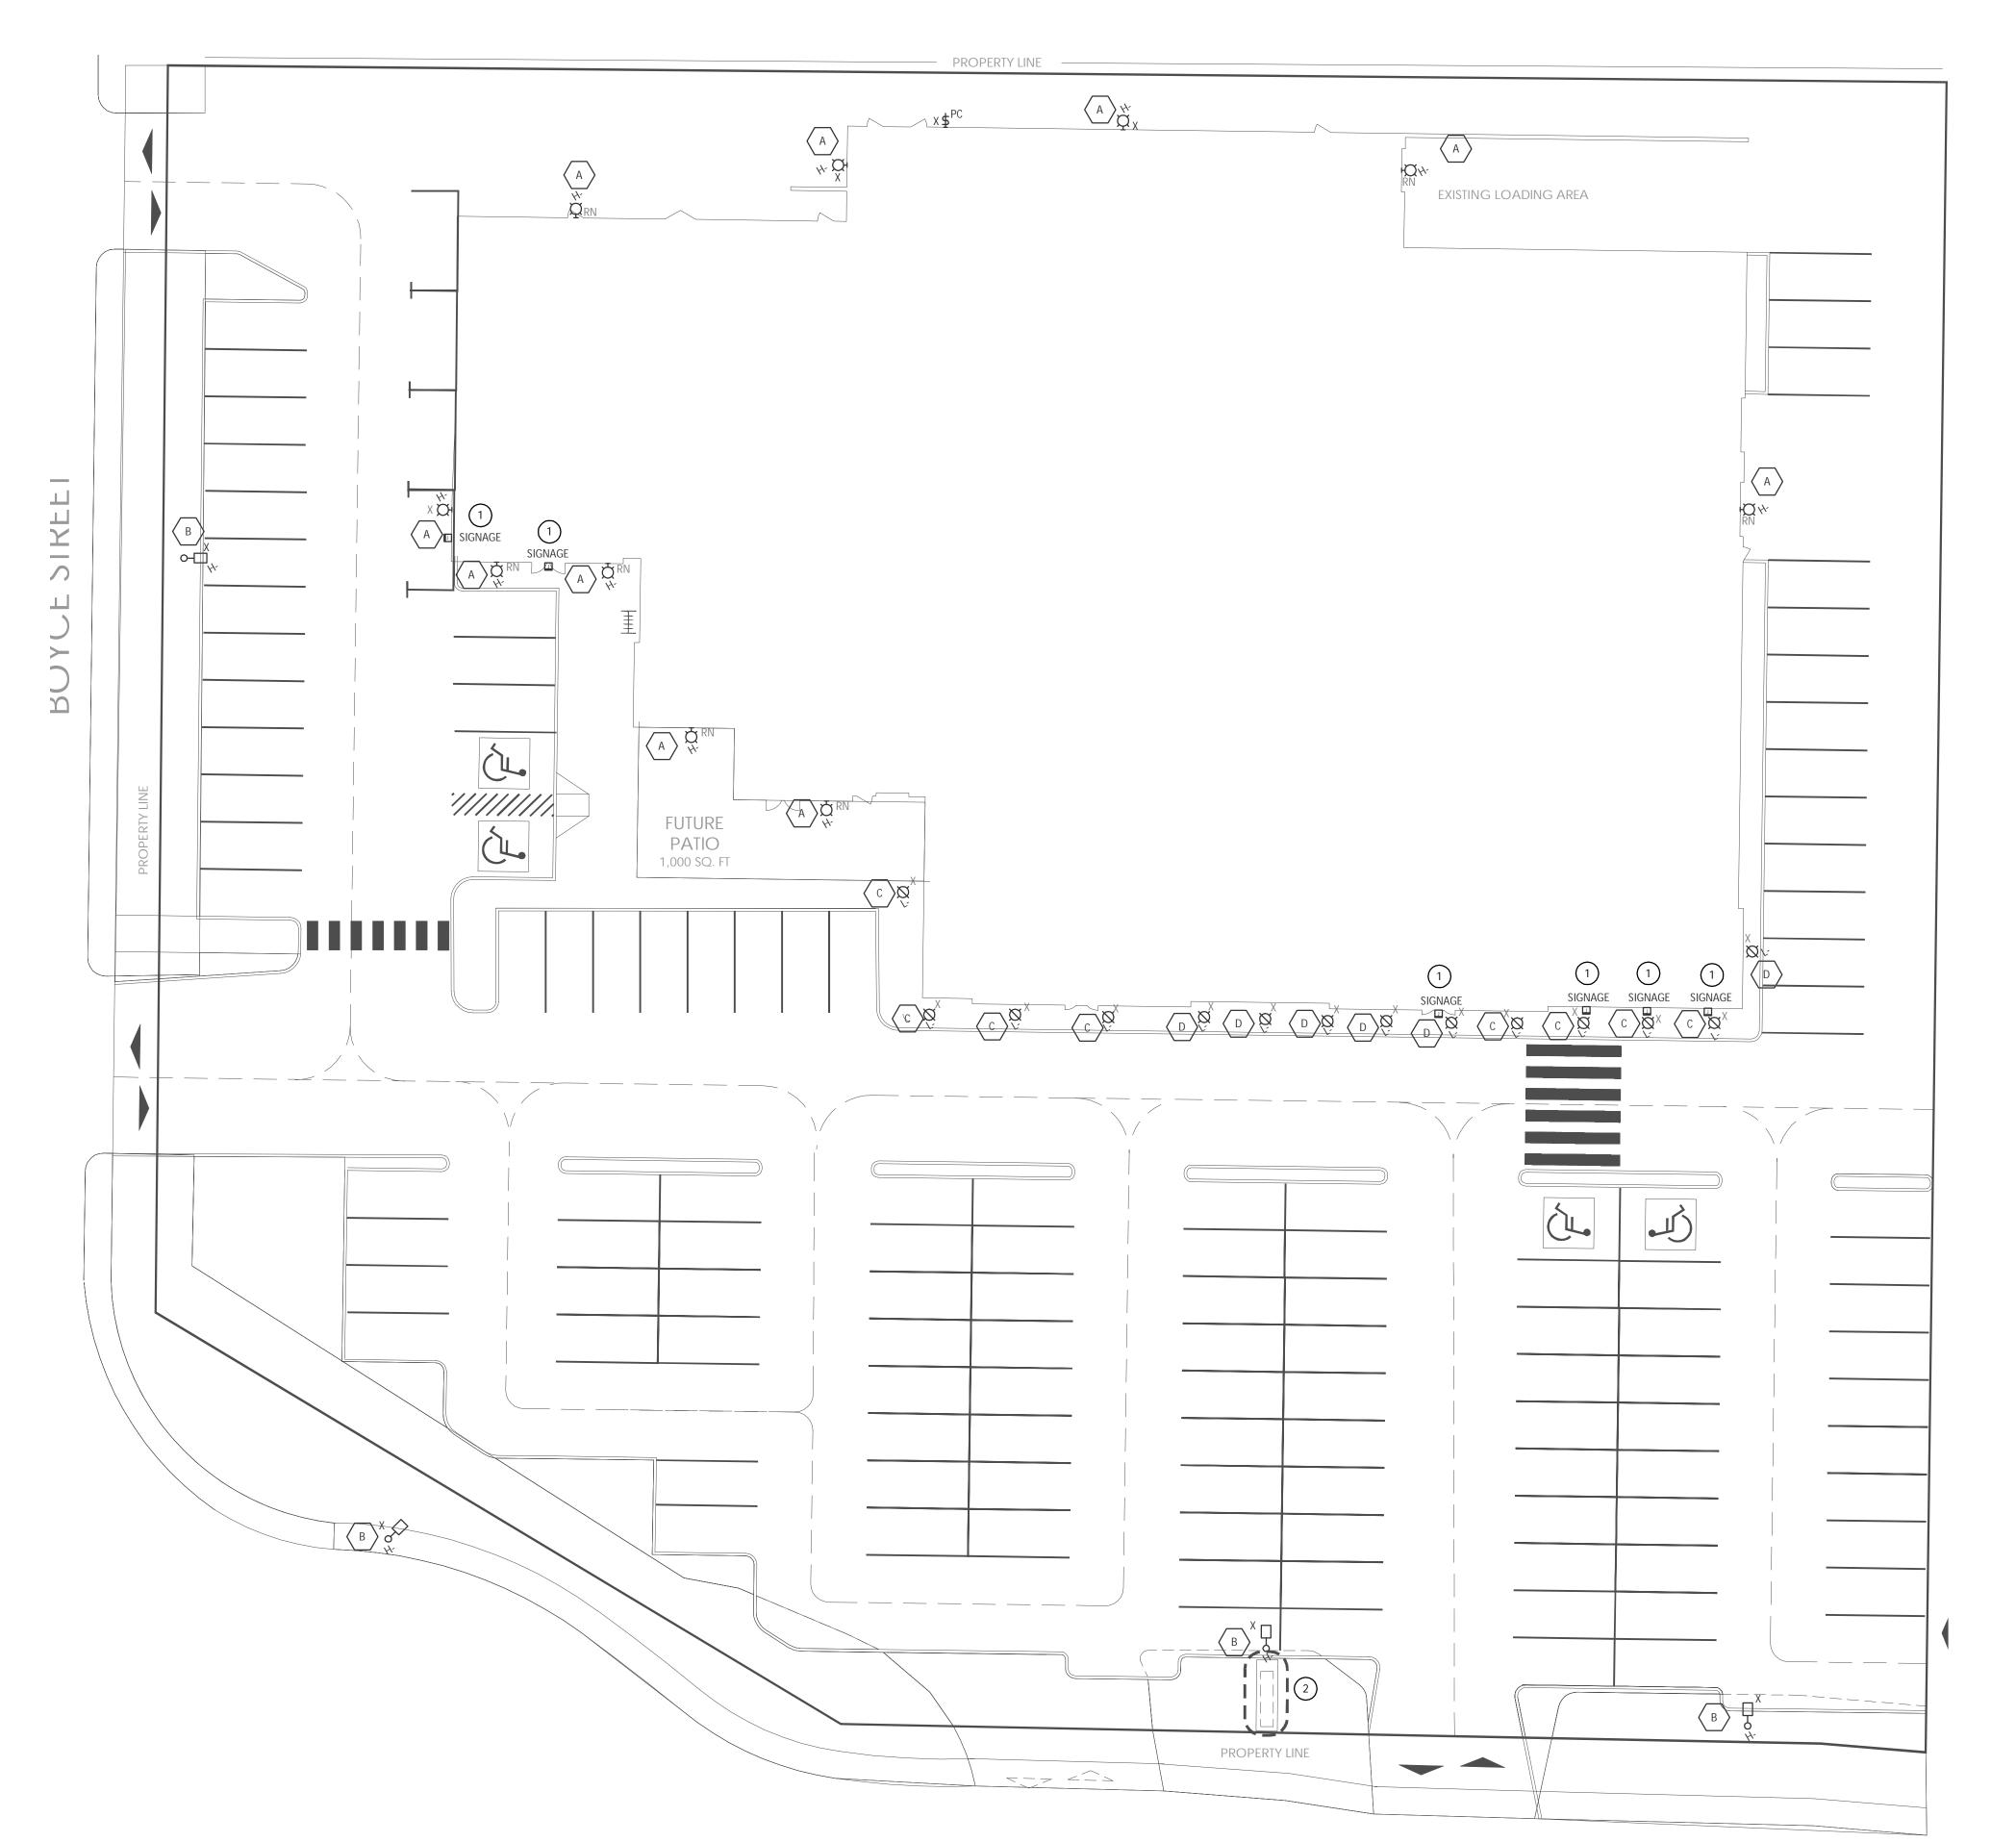

KEY NOTES:

SIGNAGE TO BE REMOVED, THEN REINSTALLED POST COMPLETION OF EXTERIOR RENOVATION.

POWER CIRCUIT TO PYLON SIGNAGE TO BE RECONNECTED TO NEW PYLON SIGNAGE.

GENERAL NOTES:

- 1. FOR ALL PENETRATIONS THROUGH FIREWALLS AND FIRE COMPARTMENTS, USE THE APPROPRIATELY RATED FIRESTOPPING ASSEMBLY.
- . "RN" INDICATES EXISTING LIGHT FIXTURE IS TO BE REMOVED AND THEN REPLACED WITH NEW FIXTURE POST COMPLETION OF EXTERIOR RENOVATION AS SHOWN ON DRAWING E2.0.
- "X" INDICATES EXISTING LIGHT FIXTURE TO BE REMOVED.
- 4. ELECTRICAL CONTRACTOR IS RESPONSIBLE TO VERIFY ALL EXTERIOR LIGHTING CIRCUITS TO BE FED AND CONTROLLED FROM HOUSE PANEL LOCATED IN FACILITY'S MAIN ELECTRICAL ROOM.

TYPE	DESCRIPTION	LAMP
A	HPS WALL PACK - SURROUNDING BUILDING EXTERIOR	1X HPS-250W
В	HPS POLE MOUNTED WALL PACK - PARKING LOT LIGHTING	1X HPS-250W
С	8" ROUND POT LIGHTS - UNDER CANOPY LIGHTING	1X HPS-70W
D	12" Square Pot Lights - Under Canopy Lighting	1X HPS-70W





CONSULTANT



DEBORES DEBORES

PERMIT NUMBER: P11753

3	2014-08-22	Issued for Building Permit	BS	BdE
2	2014-08-22	Issued for Pricing	BS	BdE
1	2014-08-18	Issued for Review	BS	Bdl
NO.	YY-MM-DD	REVISION / DRAWING ISSUE	DRAWN	RFVIF

CONSTRUCTION MANAGER



THIS DRAWING, AS AN INSTRUMENT OF SERVICE IS THE PROPERTY OF KEDDIE ARCHITECTURE INC, THE COPYRIGHT IN THE SAME BEING RESERVED TO THEM. NO REPRODUCTION IS ALLOWED WITHOUT THE PERMISSION OF KEDDIE ARCHITECTURE INC AND WHEN MADE MUST BEAR ITS NAME. THIS DRAWING IS NOT TO BE SCALED. THE CONTRACTOR IS TO VERIFY DIMENSIONS AND DATA NOTED HEREIN WITH THE CONDITIONS ON SITE AND IS RESPONSIBLE FOR REPORTING ANY DISCREPANCY TO KEDDIE ARCHITECTURE INC FOR ADJUSTMENT.

PROJE

EXTERIOR LIGHTING PLAN

24 2119 50th AVENUE RED DEER, AB

DRAWING TITLE

DEMOLITION EXTERIOR LIGHTING LAYOUT

DRAWING ISSUED

DRAWING NO.

ISSUED FOR BUILDING PERMIT/PRICING

PROJECT NO. PLOT DATE


14019.10 SCALE

E1.0

1:200



LANDSCAPED LANE

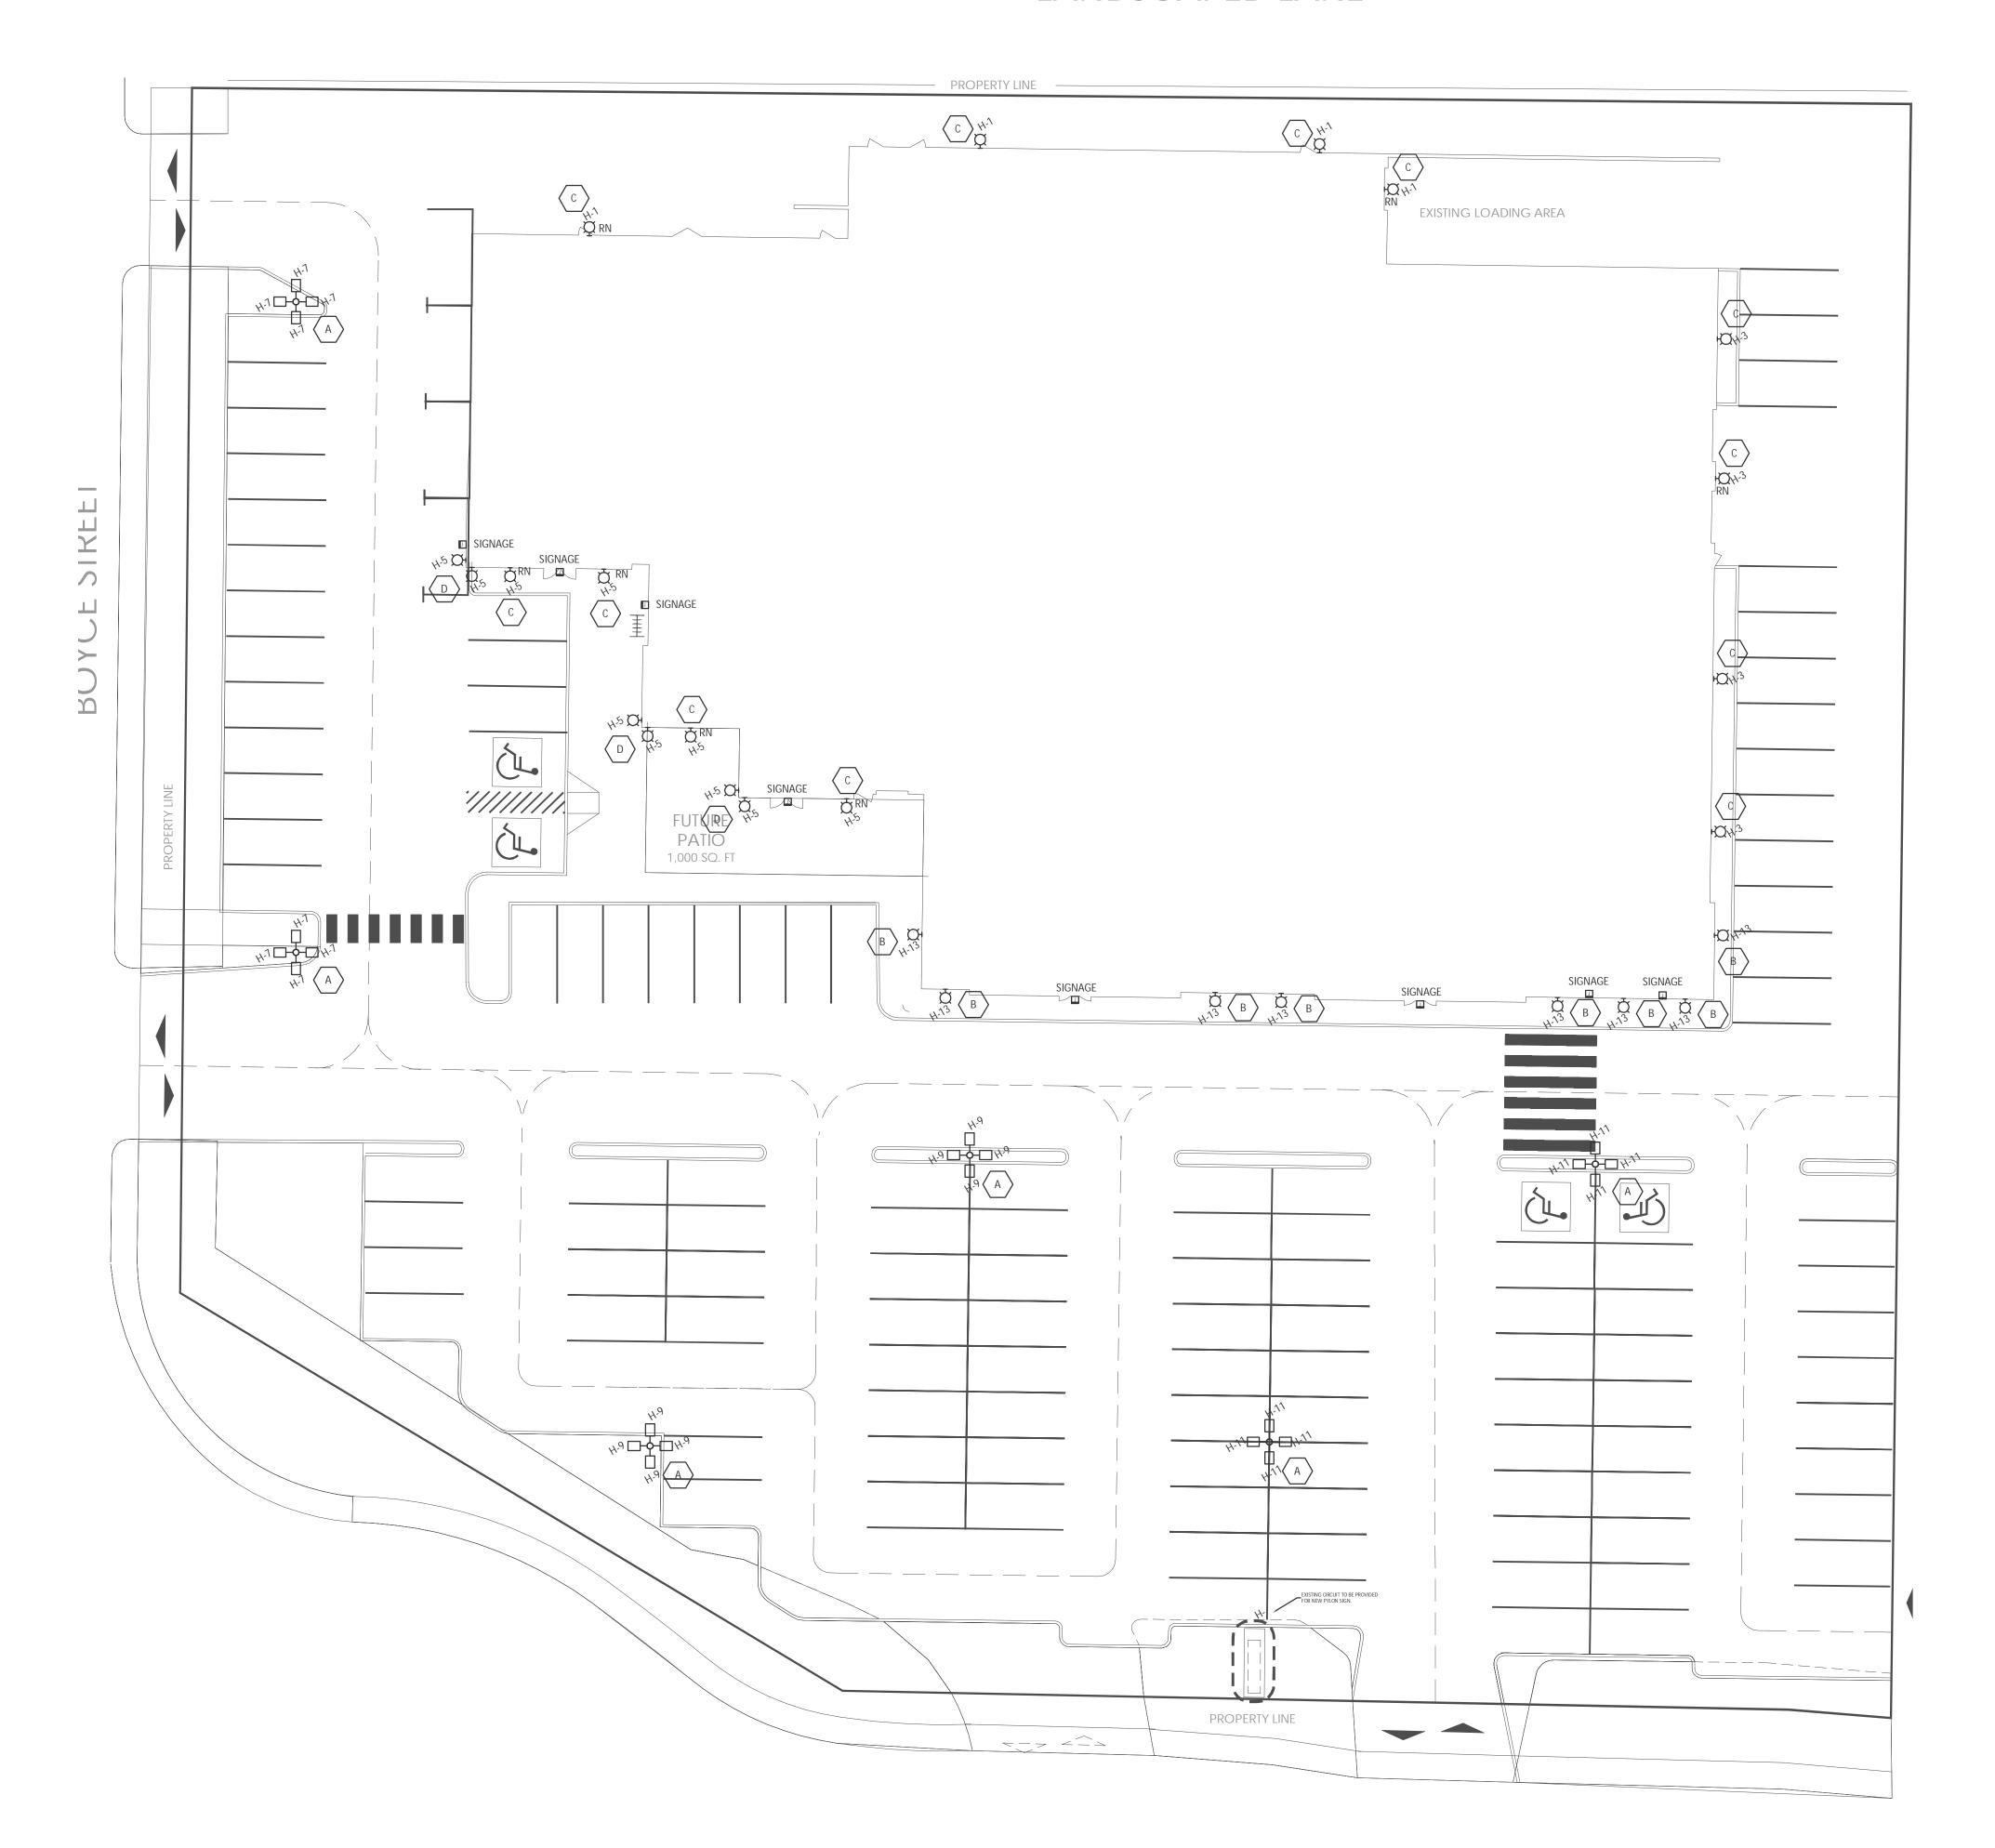

GENERAL NOTES:


- 1. "RN" INDICATES NEW LIGHT FIXTURE TO BE INSTALLED IN EXISTING LOCATION. REFER TO E1.0 FOR CLARIFICATION.
- 2. ALL LIGHTING CIRCUITS TO BE CONTROLLED THROUGH LIGHTING CONTACTOR LOCATED IN MAIN ELECTRICAL ROOM REFER TO DRAWING E3.0.
- ALL LIGHTING CIRCUITS TO BE FED FROM MAIN HOUSE PANEL LOCATED IN MAIN ELECTRICAL ROOM.
 ELECTRICAL CONTRACTOR TO MOUNT FIXTURES AT EXISTING FIXTURE HEIGHTS.



CONSULTANT



JLAL

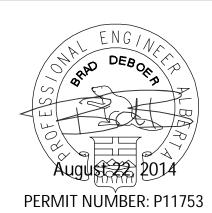

3	2014-08-22	Issued for Building Permit	BS	BdB
2	2014-08-22	Issued for Pricing	BS	BdB
1	2014-08-18	Issued for Review	BS	BdB
IO.	YY-MM-DD	REVISION / DRAWING ISSUE	DRAWN	REVIE



THIS DRAWING, AS AN INSTRUMENT OF SERVICE IS THE PROPERTY OF KEDDIE ARCHITECTURE INC, THE COPYRIGHT IN THE SAME BEING RESERVED TO THEM. NO REPRODUCTION IS ALLOWED WITHOUT THE PERMISSION OF KEDDIE ARCHITECTURE INC AND WHEN MADE MUST BEAR ITS NAME. THIS DRAWING IS NOT TO BE SCALED. THE CONTRACTOR IS TO VERIFY DIMENSIONS AND DATA NOTED HEREIN WITH THE CONDITIONS ON SITE AND IS RESPONSIBLE FOR REPORTING ANY DISCREPANCY TO KEDDIE ARCHITECTURE INC FOR ADJUSTMENT.

PROJE

EXTERIOR LIGHTING PLAN

24 2119 50th AVENUE RED DEER, AB

DRAWING TITLE

NEW EXTERIOR LIGHTING LAYOUT

DRAWING ISSUED

ISSUED FOR BUILDING PERMIT/PRICING


PROJECT NO. PLOT DATE

14019.10 SCALE

DRAWING NO.

E2.0



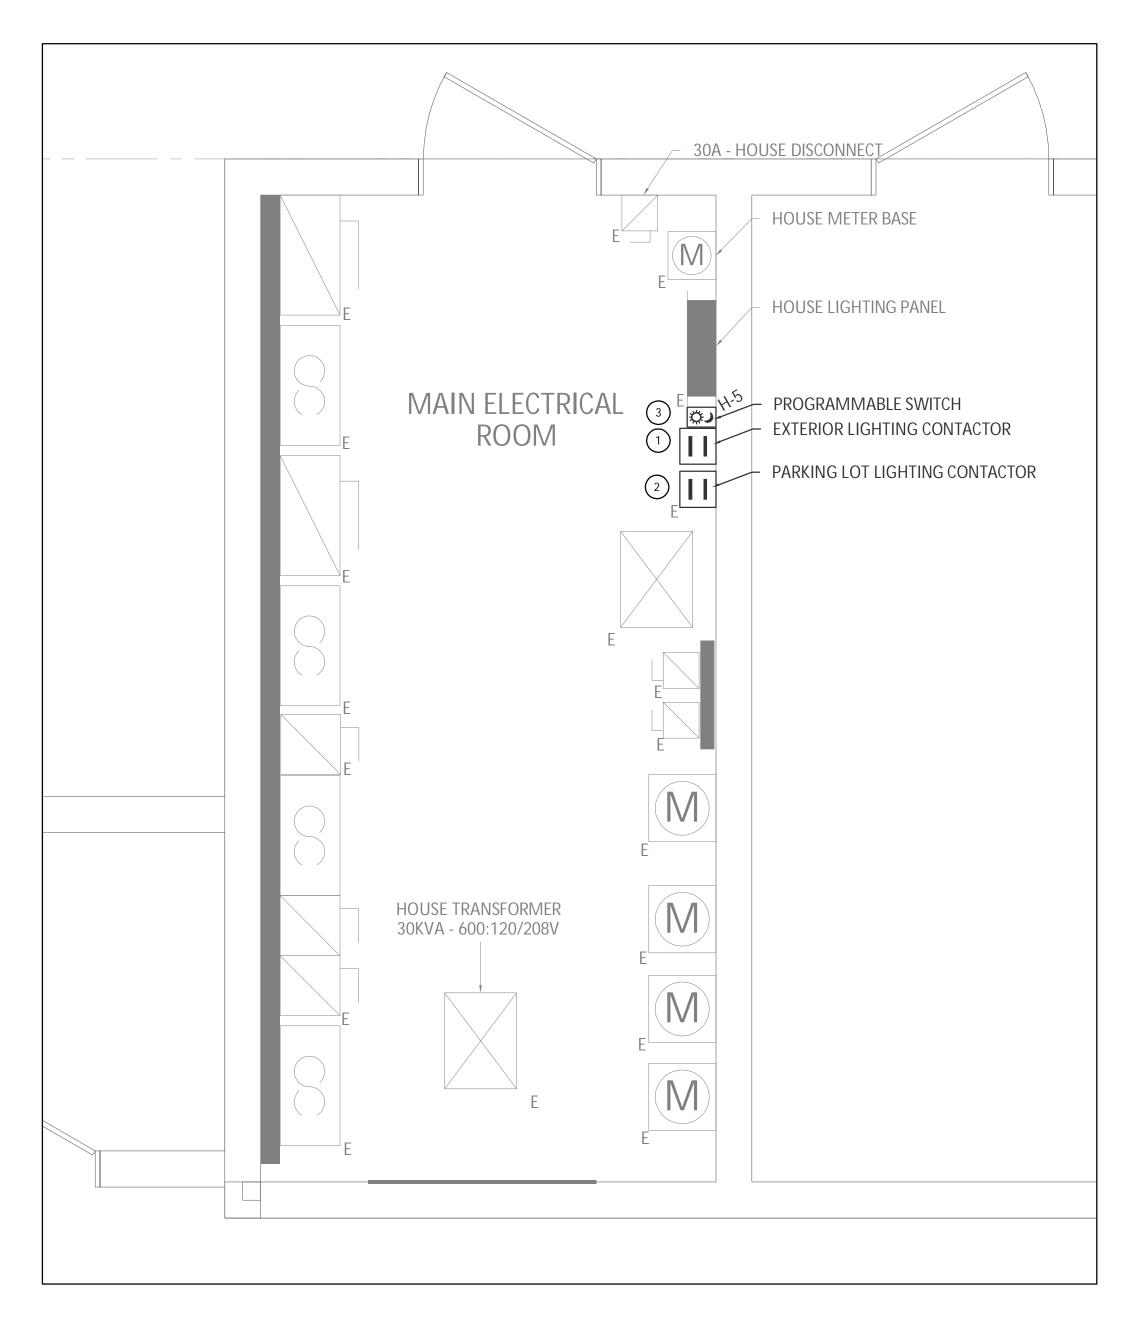

1 ELECTRICAL ROOM LAYOUT
E3.0 SCALE: 1:20

KEY NOTES:

- 1) PROVIDE ADDITIONAL 3-POLE 20A CONTACTOR IF NECESSARY TO ACCOMMODATE ADDITIONAL PARKING LOT LIGHTING CIRCUITS.
- 2 PROVIDE SEPARATE 4-POLE 20A CONTACTOR AND JUNCTION BOX FOR BUILDING EXTERIOR LIGHTING CIRCUITS.
- PROVIDE A 7-DAY SOLAR PROGRAMMABLE WALL SWITCH (HONEYWELL CAT# PLS750C) MOUNTED IN DUST TIGHT JUNCTION BOX.

MC	UNTING:	SURFACE			VO	LTAGE	12	0/208V				BUS RATING:	225 A
PAN	NEL LOCATION:	MAIN ELE	ECTRICAL R	MOON	PH	ASES	3					FED FROM: 'MAIN ELEC	CTRICAL ROOM'
LOAD SERVING:		EXTERIOR LIGHTING		WIRE CIRCUITS		4	4 30						
						30					INTERRUPTING CAPACITY:	14,000 A	
	LOAD											LOA	.D
CT.			BRKR.		kVA				kVA		BRKR.		C
IO.	DESCRIPTION		SIZE	Α	В	С		Α	В	С	SIZE	DESCRIPTION	N
1	NW EXTERIOR LIGHTING			0.60				-					
3	EAST EXTERIOR LIGHTING	ì			0.60				-				
5	DECORATIVE CORNER LIC	GHTING				-				-			
7	PARKING LOT LIGHTING			1.04				-					
9	PARKING LOT LIGHTING				1.04				-				
11	PARKING LOT LIGHTING					1.04				-			
13	VISIONS STORE FRONT LI	GHTING		0.40				-					
15					-				-				
17						-				-			
19				i				-					
21					-				-				
23						-				-			
25				-				-					
27					-				-				
29						-				-			
				2.04	1.64	1.04	L	-	-	-			
	A TOTAL LOAD =	2.04 kVA											

	LIGHTING FIXTURE SCHEDULE								
NO.	GENERAL DESCRIPTION	MOUNTING	LOCATION	VOLTAGE	LAMPS	SPECIFICATION/COMMENTS			
A	QUAD POLE ARM MOUNT LED	POLL MOUNT AT 18'	PARKING LOT	120	(1x) 130W LED	KEENE CAT# GL1843130LACWUNIVBLP			
В	LED EXTERIOR WALL MOUNT FIXTURE	WALL MOUNTED AT 8'-0" A.F.F.	VISIONS STORE FRONT	120	(1x) 50W LED	KEENE CAT# 121250LACWUNIV			
C	LED EXTERIOR WALL PACK	WALL MOUNTED AT 12'-0" A.F.F.	EXTERIOR PERIMETER	120	(1x) 150W LED	KEENE CAT# FPL08UB0546KH2			
D	WALL SCONCE	WALL MOUNTED AT 8'-0" A.F.F.	SW CORNERS	120	-	ELECTRICAL CONTRACTOR TO PROVIDE CASH ALLOWANCE OF \$500 PER FIXTURE.			

ELECTRICAL SYMBOLS LEGEND
ROUND RECESS MOUNTED LIGHT FIXTURE
ROUND WALL MOUNTED LIGHT FIXTURE
POLE MOUNTED LIGHT FIXTURE
LIGHTING CONTACTOR
DIGITAL PROGRAMMABLE TIMECLOCK
WALL MOUNTED JUNCTION BOX
KEY NOTE TAG
LIGHT FIXTURE TAG
EXISTING DEVICE TO BE REMOVED
EXISTING DEVICE TO REPLACED WITH NEW DEVICE




SEAL

CONSULTANT



SEAL

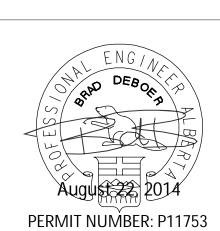

	•	ERRIT NOMBER 11700		
3	2014-08-22	Issued for Building Permit	BS	BdB
2	2014-08-22	Issued for Pricing	BS	BdB
1	2014-08-18	Issued for Review	BS	BdB
NO.	YY-MM-DD	REVISION / DRAWING ISSUE	DRAWN	REVIEW

CONSTRUCTION MANAGER



THIS DRAWING, AS AN INSTRUMENT OF SERVICE IS THE PROPERTY OF KEDDIE ARCHITECTURE INC, THE COPYRIGHT IN THE SAME BEING RESERVED TO THEM. NO REPRODUCTION IS ALLOWED WITHOUT THE PERMISSION OF KEDDIE ARCHITECTURE INC AND WHEN MADE MUST BEAR ITS NAME. THIS DRAWING IS NOT TO BE SCALED. THE CONTRACTOR IS TO VERIFY DIMENSIONS AND DATA NOTED HEREIN WITH THE CONDITIONS ON SITE AND IS RESPONSIBLE FOR REPORTING ANY DISCREPANCY TO KEDDIE ARCHITECTURE INC FOR ADJUSTMENT.

PROJECT

EXTERIOR LIGHTING PLAN

24 2119 50th AVENUE RED DEER, AB

DRAWING TITLE

SCHEDULES I

DRAWING ISSUED

ISSUED FOR BUILDING PERMIT/PRICING

PROJECT NO.

14019.10

PLOT DATE

SCALE

DRAWING NO.

E3.0

1:100

REVISION

2119 50th AVENUE

RED DEER, AB

SHOPPING CENTRE - EXTERIOR RENOVATION







6	2014-09-19	RE-ISSUED FOR PRICING	ML/KC	Cl
5	2014-09-10	RE-ISSUED FOR PRICING	ML/KC	Cl
4	2014-09-03	IFC - DRAFT - TO CONSULTANTS	ML/KC	Cl
3	2014-08-25	BUILDING PERMIT	ML/KC	Cł
2	2014-08-25	ISSUED FOR PRICING	ML/KC	Cl
1	2014-05-16	DEVELOPMENT PERMIT	ML/KC	Cl
NO.	YY-MM-DD	REVISION / DRAWING ISSUE	DRAWN	REVI

CONSTRUCTION MANAGER



THIS DRAWING, AS AN INSTRUMENT OF SERVICE IS THE PROPERTY OF KEDDIE ARCHITECTURE INC, THE COPYRIGHT IN THE SAME BEING RESERVED TO THEM. NO REPRODUCTION IS ALLOWED WITHOUT THE PERMISSION OF KEDDIE ARCHITECTURE INC AND WHEN MADE MUST BEAR ITS NAME. THIS DRAWING IS NOT TO BE SCALED. THE CONTRACTOR IS TO VERIFY DIMENSIONS AND DATA NOTED HEREIN WITH THE CONDITIONS ON SITE AND IS RESPONSIBLE FOR REPORTING ANY DISCREPANCY TO KEDDIE ARCHITECTURE INC FOR ADJUSTMENT.

SHOPPING CENTRE -**EXTERIOR RENOVATION**

#1, 2119 50 Ave, Red Deer, AB T4R 1Z4 #2, 2119 50 Ave, Red Deer, AB T4R 1Z4 #100, 2127 50 Ave, Red Deer, AB T4R 1Z4 #101, 2127 50 Ave, Red Deer, AB T4R 1Z4

DRAWING TITLE

COVER SHEET

DRAWING ISSUED

ISSUED FOR CONSTRUCTION

1203 SCALE

DRAWING NO.

A0.00

2014-09-19

N.T.S.









GENERAL NOTES:

- THESE DRAWINGS ARE TO BE READ IN CONJUNCTION WITH ALL CONSULTANT DRAWINGS AND SPECIFICATIONS.
- 2. THE CONTRACTOR SHALL REVIEW THE EXISTING PREMISES CAREFULLY PRIOR TO COMMENCING CONSTRUCTION; ANY SITE CONDITION OR DIMENSIONS FOUND TO BE DIFFERENT THAN THOSE SHOWN ON THE DRAWINGS, SHALL BE REPORTED TO THE ARCHITECT IMMEDIATELY PRIOR TO PROCEEDING WITH WORK.
- 3. ALL WORK TO COMPLY WITH THE MOST CURRENT EDITION OF THE ALBERTA BUILDING CODE (2006 ABC) AND REFERENCED DOCUMENTS.
- 4. CONSTRUCTION STANDARDS FOR MATERIAL AND WORKMANSHIP QUALITY MUST COMPLY WITH PREVAILING COMMONLY RECOGNIZED CONSTRUCTION INDUSTRY STANDARDS.
- 5. ALL MATERIAL, EQUIPMENT, FIXTURES AND FITTINGS TO BE NEW UNLESS OTHERWISE NOTED, AND INSTALLED ACCORDING TO MANUFACTURERS' RECOMMENDATIONS.
- 6. CONFIRM ALL SIZES OF TENANT'S EQUIPMENT AND APPLIANCES.
- 7. ALL PENETRATIONS THOUGH FIREWALLS, ARE TO BE PACKED WITH MINERAL FIBRE INSULATION AND CAULKED TO MAINTAIN INTEGRITY OF THE SEPARATION. ALL CONTRACTORS ARE RESPONSIBLE FOR THEIR OWN FIRESTOPPING UNLESS NOTED OTHERWISE.
- 8. ALL PARTITIONS THAT CONTINUE TO THE U/S OF STRUCTURE ARE TO HAVE DEFLECTION TRACKS.
- 9. CONCRETE SLABS ARE PRESUMED TO BE IRREGULAR, THE CONTRACTOR IS TO ANTICIPATE TOPPING, THOROUGHLY CLEAN EXISTING CONCRETE SLAB OF ALL ADHESIVE AND DEBRIS. FLOAT TO LEVEL FLOOR PRIOR TO INSTALLATION OF NEW FLOOR FINISHES AND WALL CONSTRUCTION. LEVELING BED TO BE 1/4" HEIGHT MAXIMUM DIFFERENCE OVER RUN OF 10'-0".

GENERAL NOTES:

10. PROVIDE SHALL MEAN SUPPLY AND INSTALL.

11. ALL EXISTING SURFACES TO REMAIN ARE TO BE PROTECTED DURING DEMOLITION & CONSTRUCTION AND SHOULD BE THOROUGHLY CLEANED WHEN CONSTRUCTION COMPLETE.

12. CONTRACTOR TO PROVIDE SHOP DRAWINGS FOR REVIEW BY ARCHITECT PRIOR TO FABRICATION.

13. CONTRACTOR TO PROVIDE SAMPLES OF ALL FINISHES AND MATERIALS TO ARCHITECT FOR APPROVAL.

FLOOR ASSEMBLIES

- **EXISTING CONCRETE FLOOR SLAB** -EXISTING CONCRETE FLOOR SLAB -EXISTING 6 MIL VAPOUR BARRIER -EXISTING COMPACTED GRANULAR BASE
- **EXISTING CONCRETE SIDEWALK** -EXISTING CONCRETE SLAB -EXISTING 6 MIL VAPOUR BARRIER -EXISTING COMPACTED GRANULAR BASE
- **CONCRETE FLOOR SLAB** -REINFORCED CONCRETE SLAB AS PER STRUCTURAL -6 MIL VAPOUR BARRIER -COMPACTED GRANULAR BASE
- -CONCRETE SLAB AS PER STRUCTURAL -6 MIL VAPOUR BARRIER -COMPACTED GRANULAR BASE

ROOF ASSEMBLIES

EXISTING ROOF -EXISTING ROOF MEMBRANE -EXISTING PROTECTION BOARD -EXISTING INSULATION -EXISTING VAPOUR BARRIER -EXISTING METAL ROOF DECK

SOFFIT ASSEMBLIES

-38mm EIFS -TROWEL APPLIED BREATHABLE MOISTURE BARRIER -13mm EXTERIOR FIBREGLASS MATT GYPSUM BOARD -92mm STEEL STUD FRAMING, AS REQUIRED -VENTED VOID SPACE

EXTERIOR WALL ASSEMBLIES

EXISTING EXTERIOR WALL - CONCRETE MASONRY UNIT -EXISTING 90mm CMU -EXISTING 25mm AIR SPACE

-EXISTING 50mm RIGID INSULATION EXISTING A/V BARRIER -EXISTING 190mm CMU -EXISTING STEEL STUD FRAMING

-EXISTING 13mm GWB NOTE: WALL ASSEMBLY TO BE CONFIRMED ON-SITE

EXTERIOR WALL - STONE VENEER -25mm STONE VENEER -13mm MORTAR SETTING BED -PAPER BACKED METAL LATHE (3.4 LB) -100mm ADJUSTABLE Z-GIRTS @ 400 O.C. -50mm AIR SPACE -75mm RIGID INSULATION -A/V BARRIER MEMBRANE -EXISTING 190mm CMU EXISTING STEEL STUD FRAMING -EXISTING 13mm GWB

EXTERIOR WALL - STONE VENEER -25mm STONE VENEER -13mm MORTAR SETTING BED -PAPER BACKED METAL LATHE (3.4 LB) -125mm ADJUSTABLE Z-GIRTS @ 400 O.C -50mm AIR SPACE -75mm RIGID INSULATION -A/V BARRIER MEMBRANE -EXISTING 190mm CMU -EXISTING STEEL STUD FRAMING

-EXISTING 13mm GWB

EXTERIOR WALL - EIFS

-38mm EIFS -TROWEL APPLIED BREATHABLE MOISTURE BARRIER -13mm EXTERIOR FIBREGLASS MATT GYPSUM BOARD -92mm STEEL STUD FRAMING, AS REQUIRED -VENTED VOID SPACE -89mm SEMI-RIGID INSULATION -A/V BARRIER MEMBRANE -EXISTING 190mm CMU -EXISTING STEEL STUD FRAMING

-EXISTING 13mm GWB **EXTERIOR WALL - STONE VENEER** -25mm STONE VENEER

-13mm MORTAR SETTING BED -PAPER BACKED METAL LATHE (3.4 LB) -100mm ADJUSTABLE Z-GIRTS @ 400 O.C. -25mm AIR SPACE -75mm RIGID INSULATION -A/V BARRIER MEMBRANE -13mm FIBREGLASS FACED GYPSUM SHEATHING -152mm WIND BEARING STEEL STUDS @ 400 O.C. -13mm GWB

EXTERIOR WALL - STONE VENEER -25mm STONE VENEER -13mm MORTAR SETTING BED -PAPER BACKED METAL LATHE (3.4 LB) -100mm ADJUSTABLE Z-GIRTS @ 400 O.C. -25mm AIR SPACE -75mm RIGID INSULATION -A/V BARRIER MEMBRANE -13mm FIBREGLASS FACED GYPSUM SHEATHING

-13mm GWB **EXTERIOR WALL - EIFS** -38mm EIFS -TROWEL APPLIED BREATHABLE MOISTURE BARRIER -EXISTING SHEATHING -EXISTING 38 x 140 WOOD STUDS @ 400 O.C.

-EXISTING BATT INSULATION

-EXISTING VAPOUR BARRIER

-152mm WIND BEARING STEEL STUDS @ 400 O.C.

EXTERIOR WALL - EIFS -38mm EIFS

-EXISTING GWB

-TROWEL APPLIED BREATHABLE MOISTURE BARRIER -13mm EXTERIOR FIBREGLASS MATT GYPSUM BOARD -92mm STEEL STUD FRAMING, AS REQUIRED -VENTED VOID SPACE -2 LAYERS BUILDING PAPER -EXISTING SHEATHING -EXISTING 38 x 140 WOOD STUDS @ 400 O.C. -EXISTING BATT INSULATION -EXISTING VAPOUR BARRIER

-EXISTING GWB EXTERIOR WALL - EIFS

-75mm EIFS -TROWEL APPLIED BREATHABLE MOISTURE BARRIER -EXISTING 190mm CMU -EXISTING STEEL STUD FRAMING -EXISTING 13mm GWB

CODE ANALYSIS ALBERTA BUILDING CODE 2006

LOCAL AUTHORITY: CITY OF RED DEER PLANNING & DEVELOPMENT Third floor,

4914-48 Avenue, Red Deer, AB, Canada 403-342-8111

> ALBERTA BUILDING CODE 2006 **BUILDING CODE:** ALBERTA BUILDING CODE 2006 MECHANICAL CODE PLUMBING CODE OF CANADA 2010 PLUMBING CODE: CANADIAN ELECTRICAL CODE 2012 **ELECTRICAL CODE:**

> > ACCESSIBILITY CODE: Group D Division -BUILDING OCCUPANCY CLASSIFICATION: Business and personal services

Group E Division -Mercantile occupancies

NON COMBUSTIBLE/COMBUSTABLE TYPE OF CONSTRUCTION

SPRINKLERED:

29,113 SF (2,705M) TOTAL SQUARE FOOTAGE:

3.2.2 - REQUIRED FIRE RESISTANCE RATING:

BARRIER FREE DESIGN CODE

SEE SPATIAL SEPARATION AND EXPOSURE EXPOSED BUILDING FACE PROTECTION BELOW

FIRE SEPARATIONS

BETWEEN SUITES - 3.3.1.1.(1) BETWEEN MAJOR OCCUPANCIES - 3.1.3.1.

(SUPERCEDED BY 3.3.1.1)

2 HR. FS BETWEEN GROUPS E AND A2 BETWEEN SUITES - 3.3.1.1.(1) 2 HR. FS BETWEEN GROUPS A2 AND D NIL BETWEEN GROUPS D AND E BETWEEN MAJOR OCCUPANCIES - 3.1.3.1.

2 HR. FS (SUPERCEDED BY 3.3.1.1 BETWEEN GROUPS E AND A2 2 HR. FS BETWEEN GROUPS A2 AND D NIL BETWEEN GROUPS D AND E

(SUPERCEDED BY 3.3.1.1)

1 HR. FS SERVICE ROOMS - MECHANICAL - 3.6.2.1(7) 1 HR. FS SERVICE ROOMS - ELECTRICAL - 3.6.2.1(6)

SPATIAL SEPARATION & EXPOSURE PROTECTION - 3.2.3. AREA OF EXPOSED BUILDING FACE - 3.2.3.2.(1) & (2)

THE F.R.R. OF FIRE SEPARATIONS FOR COMPARTMENTALIZATION IS A MIN. 45 MINS.

AREA OF EXPOSING FACE AREA OF UNPROTECTED

NORTH WAL **WEST WALL** SOUTH WALL EAST WALL

ACCESS TO ABOVE GRADE STOREYS - 3.2.5.1 FIRE FIGHTER ACCESS IS PROVIDE ON THE WALL REQUIRED TO FACE A STREET BY ONE UNOBSTRUCTED WINDOW CONFORMING TO 3.2.5.1.(2) PER 15M OF WALL

ACCESS ROUTES - 3.2.5.4. & 3.2.5.5 THE FIRE FIGHTER ACCESS ROUTE IS WITHIN 3 AND 15 METRES OF THE BUILDING FACE HAVING THE

PRINCIPAL ENTRANCE AND FIRE FIGHTER ACCESS OPENINGS MEASURED HORIZONTALLY FROM THE BUILDING FACE.

ACCESS IS PROVIDED BY FIXED VERTICAL LADDER AND ROOF HATCH ROOF ACCESS - 3.6.4.7.

ABBREVIATIONS

ACOUSTICAL CEILING TILE

ABOVE FINISHED FLOOR

A.C.T.

A.F.F. ALT. ALTERNATE APPROX. **APPROXIMATE** ALUM. ALUMINUM A.B. **ANCHOR BOLT** ACOUST. **ACOUSTICAL** ASPH. **ASPHALT** BLK'G **BLOCKING** BD. BOARD BLDG BUILDING BFAM BOT. BOTTOM CONTR CONTRACTOR CLG. CEILING CONC. CONCRETE CONT. CONTINUOUS C.J. CONTROL JOINT COL. COLUMN C.M. CONSTRUCTION MANAGER C.M.U. CONCRETE MASONRY UNIT CLR. COMPLETE WITH c/w CTR. CENTER DN. DIA. DIAMETER DWG. DRAWING DS. **DOWNSPOUT** DOOR DTL/DET. DETAIL E.W.C. ELECTRIC WATER COOLER EXIST. **EXISTING** EXP. **EXPANSION** ELEC. **ELECTRICAL** EQUIP. **EQUIPMENT** EACH ELEV. **ELEVATION EQUAL EXISTING** FLOOR DRAIN FDN. **FOUNDATION** FLOW LINE FLR. **FLOOR FURR FURRING** FTG. FOOTING FINISH(ED) FIN. F.R.T. FIRE RESISTANT TREATED GA. GAUGE GALV. **GALVANIZED** GC. GENERAL CONTRACTOR GD. **GUTTER DRAIN** GL. GLASS GYP. **GYPSUM** GRD. GRADE G.W.B. GYPSUM WALL BOARD HDWD HARDWOOD HEIGHT HC. **HOLLOW CORE** HORIZ. HORIZONTAL H.M. **HOLLOW METAL** H.P. HIGH POINT INSIDE DIMENSION CLEAR I.D.C. INSIDE DIAMETER INSUL. INSULATION INTERIOR **JANITOR** JAN. LAV. LAVATORY LOW POINT L.P. MFR. MANUFACTURER MAX. MAXIMUM MTL. METAL MIN. MINIMUM MECH. MECHANICAL MISC. **MISCELLANEOUS** MTD. MOUNTED M.O. MASONRY OPENING N.I.C. NOT IN CONTRACT NO. NUMBER N.T.S. NOT TO SCALE O.D. OUTSIDE DIAMETER O.R.D. OVERFLOW ROOF DRAIN OH. **OVERHEAD** OPP. **OPPOSITE** O.C. ON CENTER OPN'G **OPENING** PLAM. PLASTIC LAMINATE PLATE PLYW'D. PLYWOOD PR PAIR RAD. **RADIUS** REQ'D REQUIRED REINF. REINFORCED RESIL. RESILIENT RM. ROOM R.O. **ROUGH OPENING** RWL RAINWATER LEADER SFRM. STL. STEEL SUSP. CLG. SUSPENDED CEILING SIMILAR S.O.G. SLAB ON GRADE SPEC'S. **SPECIFICATIONS** SQ. **SQUARE** STD. STANDARD STRUCT. STRUCTURAL TOP OF MASONRY T.O.M.

OPENINGS PROVIDED

T.O.S.

TPC

TTS

TYP.

U.N.O.

V.C.T.

WC

WD.

TOP OF STEEL

WATER CLOSET

TYPICAL

WITH

WOOD

TOP OF PRE CAST DOUBLE T

UNLESS NOTED OTHERWISE

VINYL COMPOSITION TILE

TOP OF CONCRETE TOPPING SLAB

OPENINGS ALLOWED

CONSULTANT PROJECT SPRAY APPLIED FIRE RESISTIVE MATERIAL



f 403.289.C020

6 2014-09-19 RE-ISSUED FOR PRICING 5 2014-09-10 RE-ISSUED FOR PRICING 4 2014-09-03 IFC - DRAFT - TO CONSULTANTS 3 2014-08-25 BUILDING PERMIT ML/KC CK 2 2014-08-25 ISSUED FOR PRICING ML/KC CK 1 2014-05-16 DEVELOPMENT PERMIT ML/KC CK NO. YY-MM-DD REVISION / DRAWING ISSUE DRAWN REVIE CONSTRUCTION MANAGER



THIS DRAWING. AS AN INSTRUMENT OF SERVICE IS THE PROPERTY OF KEDDIE ARCHITECTURE INC, THE COPYRIGHT IN THE SAME BEING RESERVED TO THEM. NO REPRODUCTION IS ALLOWED WITHOUT THE PERMISSION OF KEDDIE ARCHITECTURE INC. AND WHEN MADE MUST BEAR ITS NAME. THIS DRAWING IS NOT TO BE SCALED. THE CONTRACTOR IS TO VERIFY DIMENSIONS AND DATA NOTED HEREIN WITH THE CONDITIONS ON SITE AND IS RESPONSIBLE FOR REPORTING ANY DISCREPANCY TO KEDDIE ARCHITECTURE INC FOR ADJUSTMENT.

SHOPPING CENTRE -**EXTERIOR RENOVATION**

#1, 2119 50 Ave, Red Deer, AB T4R 1Z4 #2, 2119 50 Ave, Red Deer, AB T4R 1Z4 #100, 2127 50 Ave, Red Deer, AB T4R 1Z4 #101, 2127 50 Ave, Red Deer, AB T4R 1Z4

DRAWING TITLE

GENERAL INFORMATION AND BUILDING CODE **ANALYSIS**


DRAWING ISSUED

DRAWING NO.

ISSUED FOR CONSTRUCTION

PROJECT NO. PLOT DATE 2014-09-19 1203 SCALE AS NOTED

A0-01

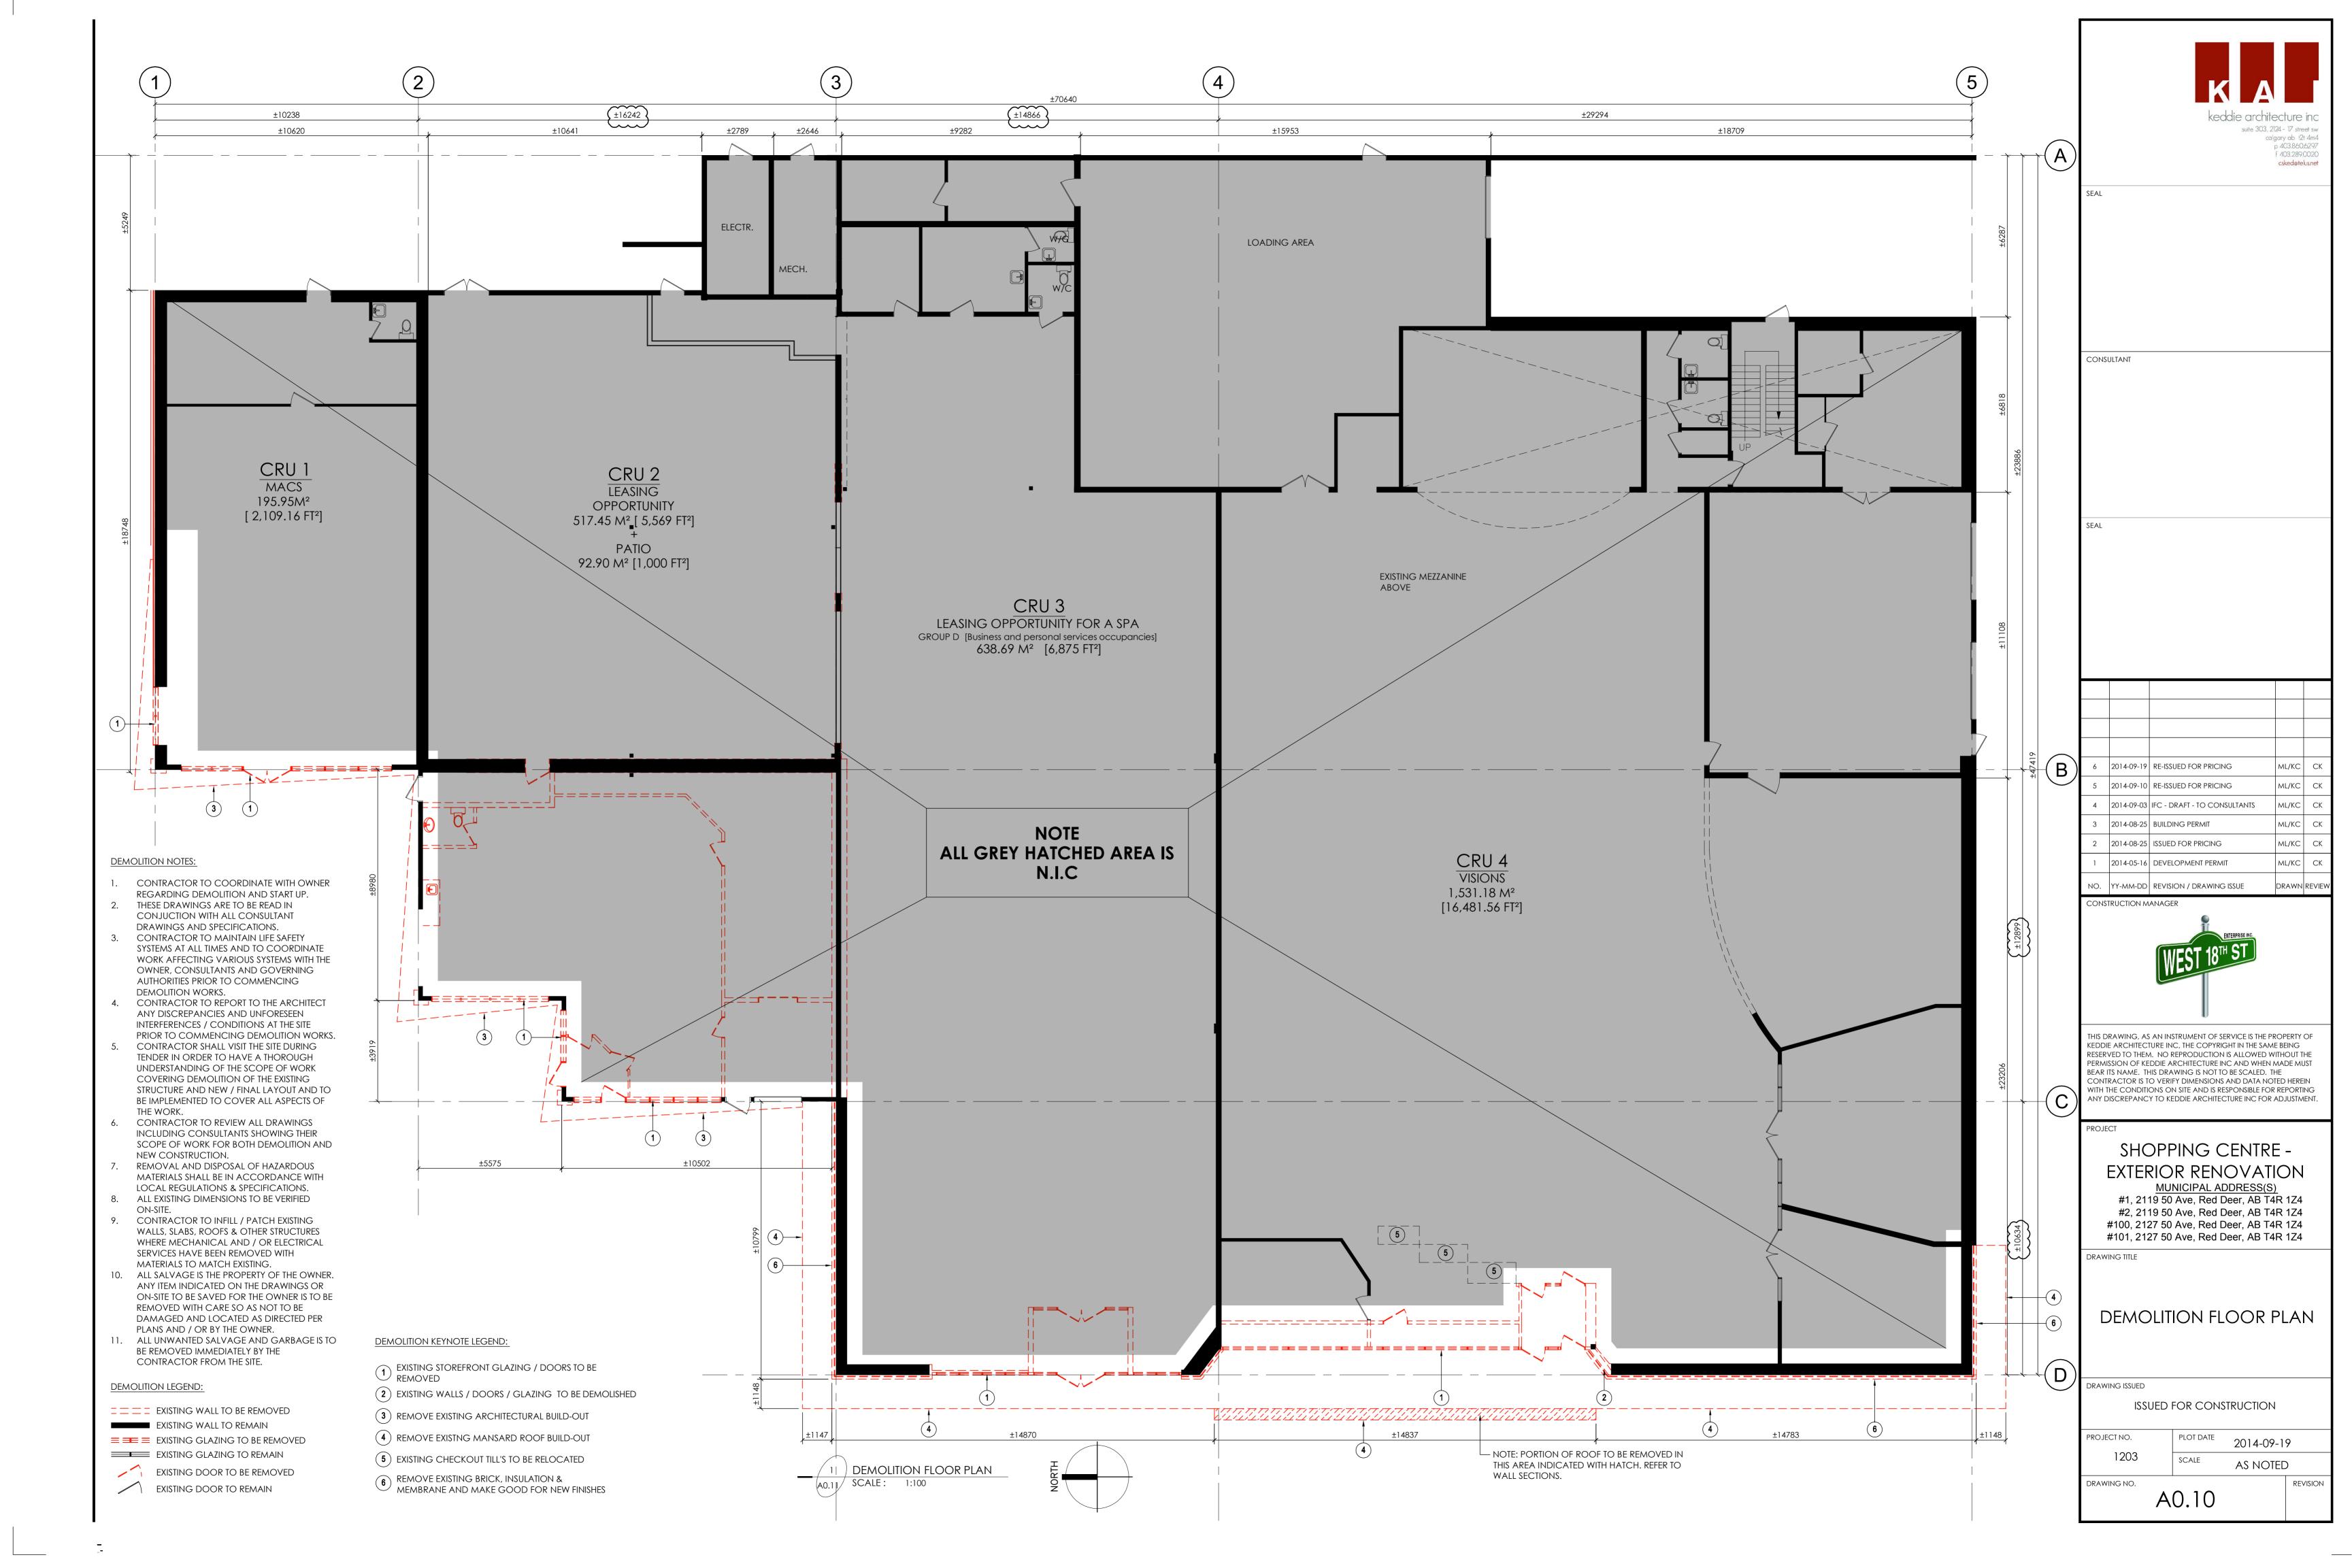





6 2014-09-19 RE-ISSUED FOR PRICING 5 2014-09-10 RE-ISSUED FOR PRICING 4 2014-09-03 IFC - DRAFT - TO CONSULTANTS 3 2014-08-25 BUILDING PERMIT 2 2014-08-25 ISSUED FOR PRICING 1 2014-05-16 DEVELOPMENT PERMIT



THIS DRAWING, AS AN INSTRUMENT OF SERVICE IS THE PROPERTY OF KEDDIE ARCHITECTURE INC, THE COPYRIGHT IN THE SAME BEING RESERVED TO THEM. NO REPRODUCTION IS ALLOWED WITHOUT THE PERMISSION OF KEDDIE ARCHITECTURE INC AND WHEN MADE MUST BEAR ITS NAME. THIS DRAWING IS NOT TO BE SCALED. THE CONTRACTOR IS TO VERIFY DIMENSIONS AND DATA NOTED HEREIN WITH THE CONDITIONS ON SITE AND IS RESPONSIBLE FOR REPORTING ANY DISCREPANCY TO KEDDIE ARCHITECTURE INC FOR ADJUSTMENT.

SHOPPING CENTRE -EXTERIOR RENOVATION

MUNICIPAL ADDRESS(S) #1, 2119 50 Ave, Red Deer, AB T4R 1Z4


#2, 2119 50 Ave, Red Deer, AB T4R 1Z4 #100, 2127 50 Ave, Red Deer, AB T4R 1Z4 #101, 2127 50 Ave, Red Deer, AB T4R 1Z4

DEMOLITION KEY PLAN WITH **VIEWS**


ISSUED FOR CONSTRUCTION

2014-09-19 SCALE **AS NOTED**


A0.11

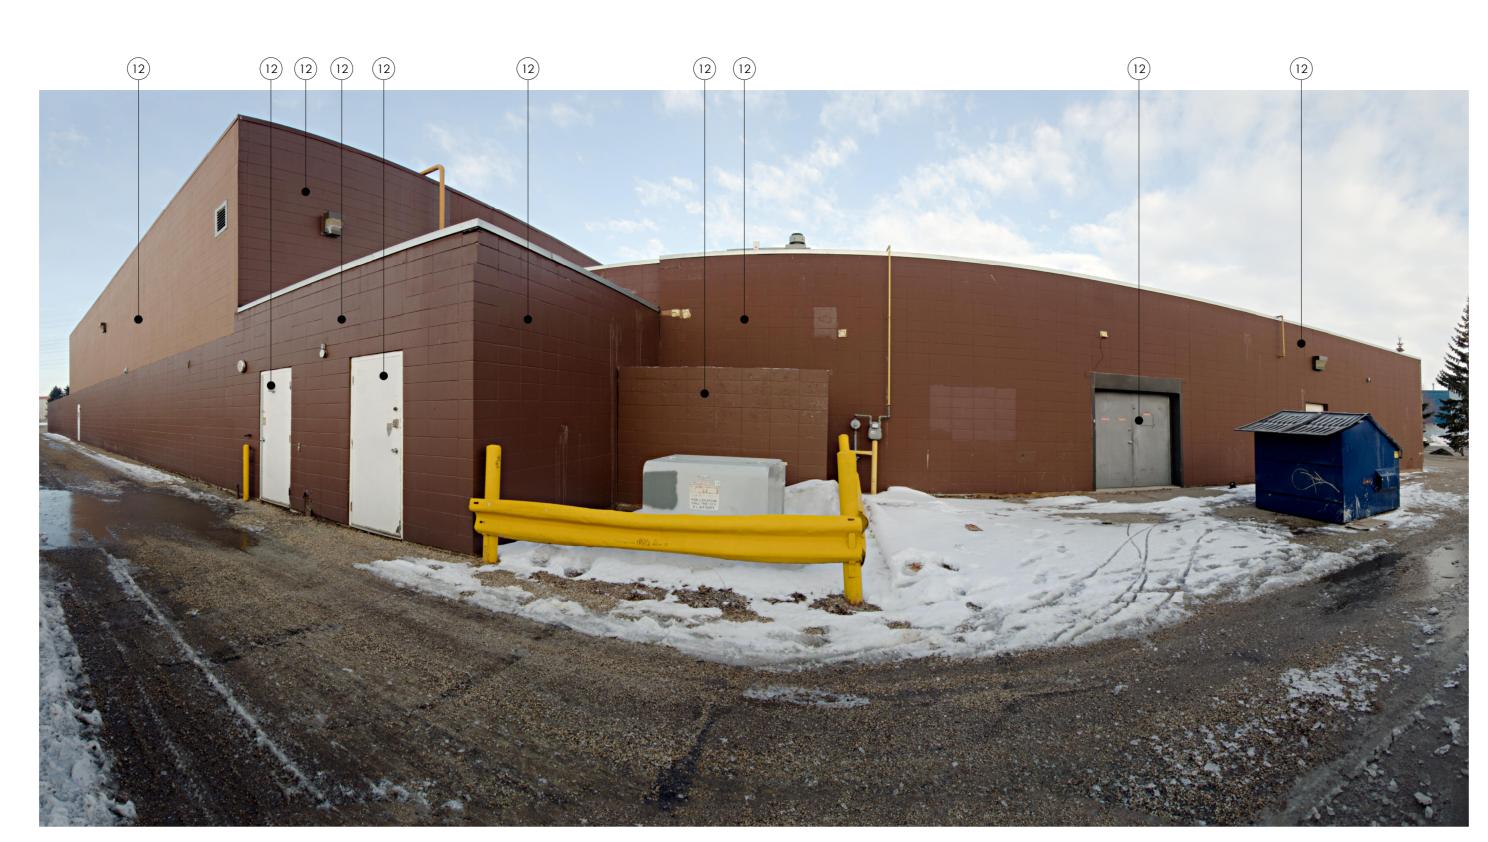




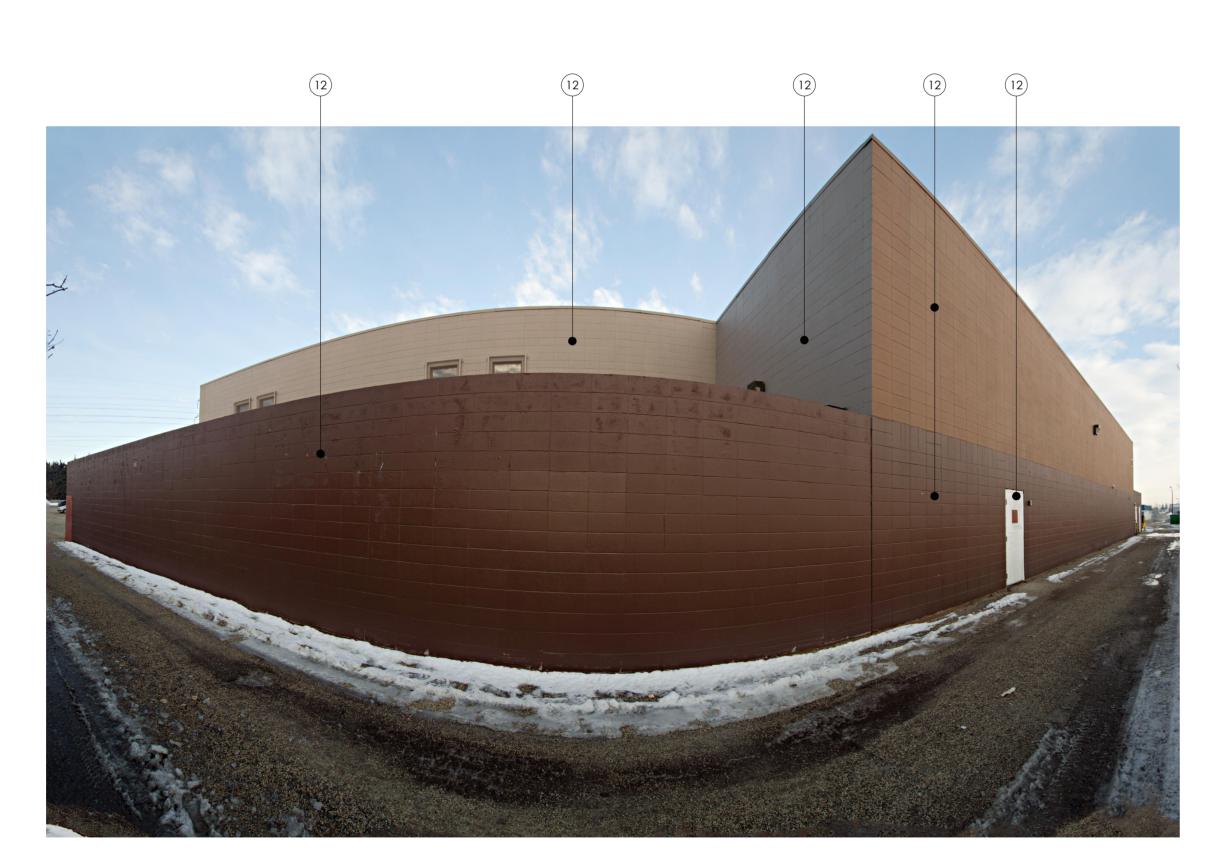



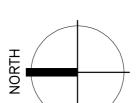

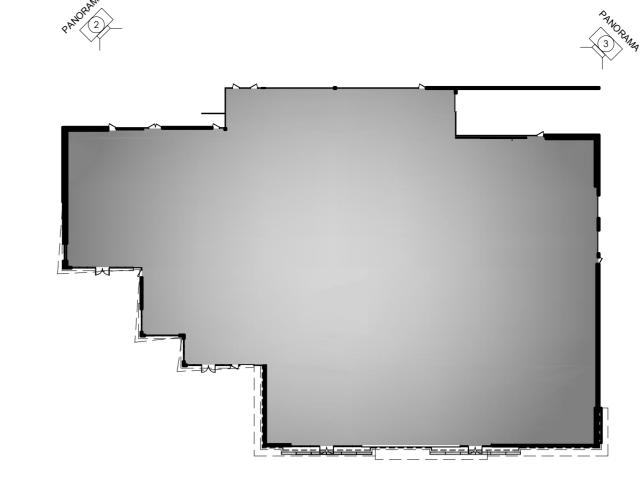

DEMO KEY PLAN INDICATING VIEWS
SCALE: N.T.S.

- 1) REMOVE/DEMOLISH MANSARD ROOF BUILDOUT
- 2 REMOVE/DEMOLISH ARCHITECTURAL BUILDOUT
- 3 REMOVE/DEMOLISH REPLACE GLAZING AND ALUMINUM STOREFRONT AND ENTRANCE -SEE ELEVATIONS AND DOOR/WINDOW SCHEDULE
- 4 REMOVE EXTERIOR LIGHT FIXTURE CLIENT TO PROVIDE SALVAGE OR DEMOLISH INSTRUCTIONS
- 5 REMOVE SIGNAGE CLIENT TO PROVIDE SALVAGE OR DEMOLISH INSTRUCTION
- 6 REMOVE/REINSTALL SIGNAGE
- 7 RELOCATE
- 8 DEMO PORTION OF WALL FOR STOREFRONT GLAZING
- 9 REMOVE AND REPLACE
- (10) DEMO PORTION OF WALL
- (11) REMOVE AND REPLACE WITH NEW DOOR SEE DOOR SCHEDULE
- 12 REPAINT EXISTING STRUCTURE
- REMOVE EXTERIOR LAYER OF EXISTING FINISH SUCH AS BRICK / STUCCO



CONSULTANT

6 2014-09-19 RE-ISSUED FOR PRICING 5 2014-09-10 RE-ISSUED FOR PRICING 4 2014-09-03 IFC - DRAFT - TO CONSULTANTS 3 2014-08-25 BUILDING PERMIT 2 2014-08-25 ISSUED FOR PRICING 1 2014-05-16 DEVELOPMENT PERMIT NO. YY-MM-DD REVISION / DRAWING ISSUE



THIS DRAWING, AS AN INSTRUMENT OF SERVICE IS THE PROPERTY OF KEDDIE ARCHITECTURE INC, THE COPYRIGHT IN THE SAME BEING RESERVED TO THEM. NO REPRODUCTION IS ALLOWED WITHOUT THE PERMISSION OF KEDDIE ARCHITECTURE INC AND WHEN MADE MUST BEAR ITS NAME. THIS DRAWING IS NOT TO BE SCALED. THE CONTRACTOR IS TO VERIFY DIMENSIONS AND DATA NOTED HEREIN WITH THE CONDITIONS ON SITE AND IS RESPONSIBLE FOR REPORTING ANY DISCREPANCY TO KEDDIE ARCHITECTURE INC FOR ADJUSTMENT.

SHOPPING CENTRE -EXTERIOR RENOVATION

MUNICIPAL ADDRESS(S) #1, 2119 50 Ave, Red Deer, AB T4R 1Z4 #2, 2119 50 Ave, Red Deer, AB T4R 1Z4 #100, 2127 50 Ave, Red Deer, AB T4R 1Z4 #101, 2127 50 Ave, Red Deer, AB T4R 1Z4

DRAWING TITLE

DEMOLITION KEY PLAN WITH **VIEWS**

DRAWING ISSUED

DRAWING NO.

ISSUED FOR CONSTRUCTION

PROJECT NO. 2014-09-19 1203 AS NOTED

A0.12

LANDSCAPED LANE RELOCATED WASTE & DP-1.2 EXISTING WOOD FENCE — 1830 R/W PLAN 782 1625 EXISTING WASTE & RECYCLING AREA TO BE RELOCATED EXISTING LOADING AREA - LANDSCAPE ADDITIONAL AREA EXISTING BUILDING 4 EXIST. PROPOSED EXTERIOR RENOVATION TRE 4 EXIST. S 5 EXIST. PATIO CONNECTION WITH EXISTING PUBLIC CRO\$SWALK NEW WIDENED NEW CONCRETE NEW CONCRETE NEW CONCRETE . NEW CONCRETE 1 EXIST. CONCRETE -ISLAND 5600 EXT 5600 EXT 5600 EXT 5600 EXT 5635 EXT 5600 EXT 3 EXIST. 4 EXIST. 3.8 METER REAR YARD 5 EXIST 5 EXIST. 6 EXIST. 6 EXIST. 51.54 M² ADDITIONAL -LANDSCAPE AREA 8 EXIST. 8 EXIST. -7.25 M2 EXISTING 8 EXIST. EXISTING PYLON SIGN LANDSCAPE AREA REMOVED TO BE REBUILT CONTINUE EXIST. SIDEWALK WITH -8.50 M2 EXISTING 9 EXIST. PROPOSED SIDEWALK WIDTH -LANDSCAPE AREA -9.51 M² DIMENSIONS AS PER EXIST. REMOVED ADDITIONAL -LANDSCAPE AREA PROPOSED 10 exist, SIDEWALK **ADDITIONAL** LANDSCAPE AREA PROPERTY LINE -8.48 M2 EXISTING LANDSCAPE AREA 153.54 M² EXISTING REMOVED 1 SITE PLAN DP1.1 SCALE: 1:200 LANDSCAPE 34.96 M² **ADDITIONAL** LANDSCAPE AREA 3.13 M² ADDITIONAL _ 9.58 M² ADDITIONAL 43.78_{M²} EXISTING EXISTING ENTRANCE REMOVED AND 44.80_{M²} EXISTING LANDSCAPE AREA LANDSCAPE AREA LANDSCAPE AREA LANDSCAPE AREA PROPOSED CROSSWALK RECLAIMED FOR PROPOSED LANDSCAPING GAETZ (50TH) AVENUE - SERVICE ROAD

CITY OF RED DEER LAND USE BYLAW 3357/2006

LEGAL DESCRIPTION: LOT 11, BLOCK 1, PLAN 832 2478 PARCEL ADDRESS: 101 2127 50 AVENUE

MUNICIPAL ADDRESS: 24 2119 50th AVENUE, RED DEER, ALBERTA
ZONING: C-4 - COMMERCIAL (MAJOR ARTERIAL) DISTRICT
USE: MERCHANDISE SALES AND/OR RENTAL

SITE AREA: 8483.01 M² FLOOR AREA: 2,704.57 M²

5.6 (2) C4 COMMERCIAL (MAJOR ARTERIAL) DISTRICT REGULATIONS

(A) TABLE 5.6. C4 REGULATIONS

REGULATIONS	REQUIREMENTS	existing	PROPOSED	TOTAL	RELAXATION/ REQUIRED
FLOOR AREA	ONE THIRD OF SITE AREA: 8483.01 M² / 3 = 2,827.68 M²	2,687.05 M²	2,704.57 M ² (17.52 M ² ADDITION)	2,704.57 M²	-
BUILDING HEIGHT MAXIMUM	THREE STOREYS - MAXIMUM	ONE STOREY	EXISTING ONE STOREY	-	-
FRONT YARD MINIMUM	15.0 m	40.1 m	EXISTING TO REMAIN	-	-
SIDE YARD NORTH MINIMUM	3.0 M WHEN IT ABUTS A STREET	16 M	EXISTING TO REMAIN	-	-
SIDE YARD SOUTH MINIMUM	3.8 M ON ONE SIDE WHEN THERE IS NO CONSTRUCTED LANE	10.8 M	EXISTING TO REMAIN	-	-
REAR YARD MINIMUM	3.0 m	3.0 M	EXISTING TO REMAIN	-	-
PARKING REQUIREMENTS TABLE 3.1	5.1 PER 93.0 M ² (GROSS FLOOR AREA): (2,704.57 M ² / 93.0 M ²) x 5.1 = 149 STALLS	119 STALLS	13 STALLS	132 STALLS	17 STALLS * SEE NOTE 2
BARRIER FREE PARKING STALLS	3 STALLS REQUIRED AS PER ABC 3.8.2.2.	2 STALLS	2 STALLS	4 STALLS	-
LOADING SPACES MINIMUM	1	1 EXISTING	EXISTING TO REMAIN	-	-
SITE AREA	MINIMUM 1393 M² MAXIMUM 4.0 Ha	8483.1 M²	EXISTING TO REMAIN	-	-
FRONTAGE	MINIMUM 103.7 M				

(3.6) LANDSCAPING REGULATIONS


REGULATIONS	REQUIREMENTS	EXISTING	PROPOSED	TOTAL	RELAXATION/ REQUIRED
LANDSCAPED AREA MINIMUM	40% OF MINIMUM FRONT YARD: 1560.56 M ² X .40 = 624.22 M ²	322.38 M²	155.44 M²	477.82 M²	-146.4M² * SEE NOTE 1
LANDSCAPING REGULATIONS	MAIN ENTRY AREA: ONE TREE PER 40 M ² OF LANDSCAPE AREA = 15 TREES (8 CONIFEROUS & 7 DECIDUOUS)	9 TREES 6 CONIFEROUS 3 DECIDUOUS	-	-	-
MAIN ENTRY AREA (WEST SIDE): TREES	ONE TREE PER 40 M ² OF LANDSCAPE AREA = 9 TREES (5 CONIFEROUS & 4 DECIDUOUS)	5 TREES (2 CONIFEROUS) (3 DECIDUOUS)	4 TREES (3 CONIFEROUS) (1 DECIDUOUS)	9 TREES (5 CONIFEROUS) (4 DECIDUOUS)	-
MAIN ENTRY AREA (WEST SIDE): SHRUBS	TWO SHRUBS PER 40 M ² OF LANDSCAPE AREA = 19 SHRUBS (10 CONIFEROUS & 9 DECIDUOUS)	9 SHRUBS (CONIFEROUS)	10 SHRUBS (9 DECIDUOUS) (1 CONIFEROUS)	19 SHRUBS (9 DECIDUOUS) (10 CONIFEROUS)	-
ALL OTHER AREAS (NORTH SIDE): TREES	ONE TREE PER 60 M ² OF LANDSCAPE AREA = 2 TREES (1 CONIFEROUS & 1 DECIDUOUS)	4 TREES (4 CONIFEROUS)	2 TREES (1 CONIFEROUS) (1 DECIDUOUS)	6 TREES (1 DECIDUOUS) (5 CONIFEROUS)	-
ALL OTHER AREAS (NORTH SIDE): SHRUBS	ONE SHRUB PER 30 M ² OF LANDSCAPE AREA = 3 SHRUBS (2 CONIFEROUS & 1 DECIDUOUS)	O SHRUBS	18 SHRUBS (9 DECIDUOUS) (9 CONIFEROUS)	18 SHRUBS (9 DECIDUOUS) (9 CONIFEROUS)	-
TOTAL		9 TREES 9 SHRUBS	6 TREES 28 SHRUBS	15 TREES 37 SHRUBS	-

NOTES

1. TOTAL LANDSCAPING AREA IS 914.4 M² TOTAL WHEN INCLUDING LANDSCAPING BETWEEN PROPERTY LINE AND ROADS.

2. ALL EXISTING PARKING STALLS ARE TO REMAIN IS INDICATED AS "EXIST." THE BUILDING AREA IS ONLY BEING INCREASED BY 17.52 M² WHICH AMOUNTS TO AN INCREASE OF 1 STALL IN THE NUMBER OF REQUIRED PARKING STALLS. INCLUDED IN THE EXISTING PARKING PROVIDED ARE THE 11 STALLS ALONG THE SOUTH SIDE OF THE PROPERTY LINE THAT ARE SHARED WITH ADJACENT SITE.

LEGEND:

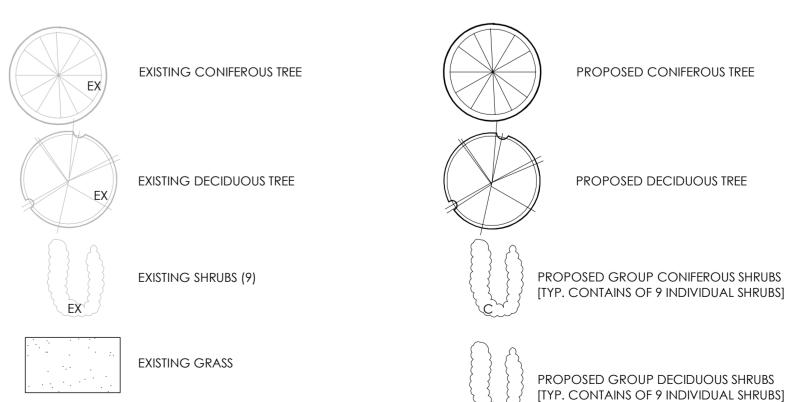

EXISTING TO REMAIN

ADDITIONAL LANDSCAPE AREA

EXTERIOR RENOVATION

MUNICIPAL ADDRESS(S)

#1 2119 50 Ave. Red Deer, AB T4R 174

6 2014-09-19 RE-ISSUED FOR PRICING

5 2014-09-10 RE-ISSUED FOR PRICING

3 2014-08-25 BUILDING PERMIT

CONSTRUCTION MANAGER

2 2014-08-25 ISSUED FOR PRICING

2014-05-16 DEVELOPMENT PERMIT

NO. YY-MM-DD REVISION / DRAWING ISSUE

4 2014-09-03 IFC - DRAFT - TO CONSULTANTS

#1, 2119 50 Ave, Red Deer, AB T4R 1Z4 #2, 2119 50 Ave, Red Deer, AB T4R 1Z4 #100, 2127 50 Ave, Red Deer, AB T4R 1Z4 #101, 2127 50 Ave, Red Deer, AB T4R 1Z4

HIS DRAWING, AS AN INSTRUMENT OF SERVICE IS THE PROPERTY OF

EDDIE ARCHITECTURE INC, THE COPYRIGHT IN THE SAME BEING

RESERVED TO THEM. NO REPRODUCTION IS ALLOWED WITHOUT THE

PERMISSION OF KEDDIE ARCHITECTURE INC AND WHEN MADE MUST BEAR ITS NAME. THIS DRAWING IS NOT TO BE SCALED. THE

CONTRACTOR IS TO VERIFY DIMENSIONS AND DATA NOTED HEREIN

WITH THE CONDITIONS ON SITE AND IS RESPONSIBLE FOR REPORTING ANY DISCREPANCY TO KEDDIE ARCHITECTURE INC FOR ADJUSTMENT.

SHOPPING CENTRE -

DRAWING TITLE

SITE PLAN

DRAWING ISSUED

EXISTING LIGHT STANDARD

PROPOSED LIGHT STANDARD

PEDESTRIAN CONNECTION

ISSUED FOR CONSTRUCTION

PROJECT NO.

1203

PLOT DATE

2014-09-19

SCALE

AS NOTED

DRAWING NO. A 1.01


AS NOTED


REVISION


suite 303, 2124 - 17 street sw

calgary ab t2t 4m4 p 403.860.6297

f 403.289.0020

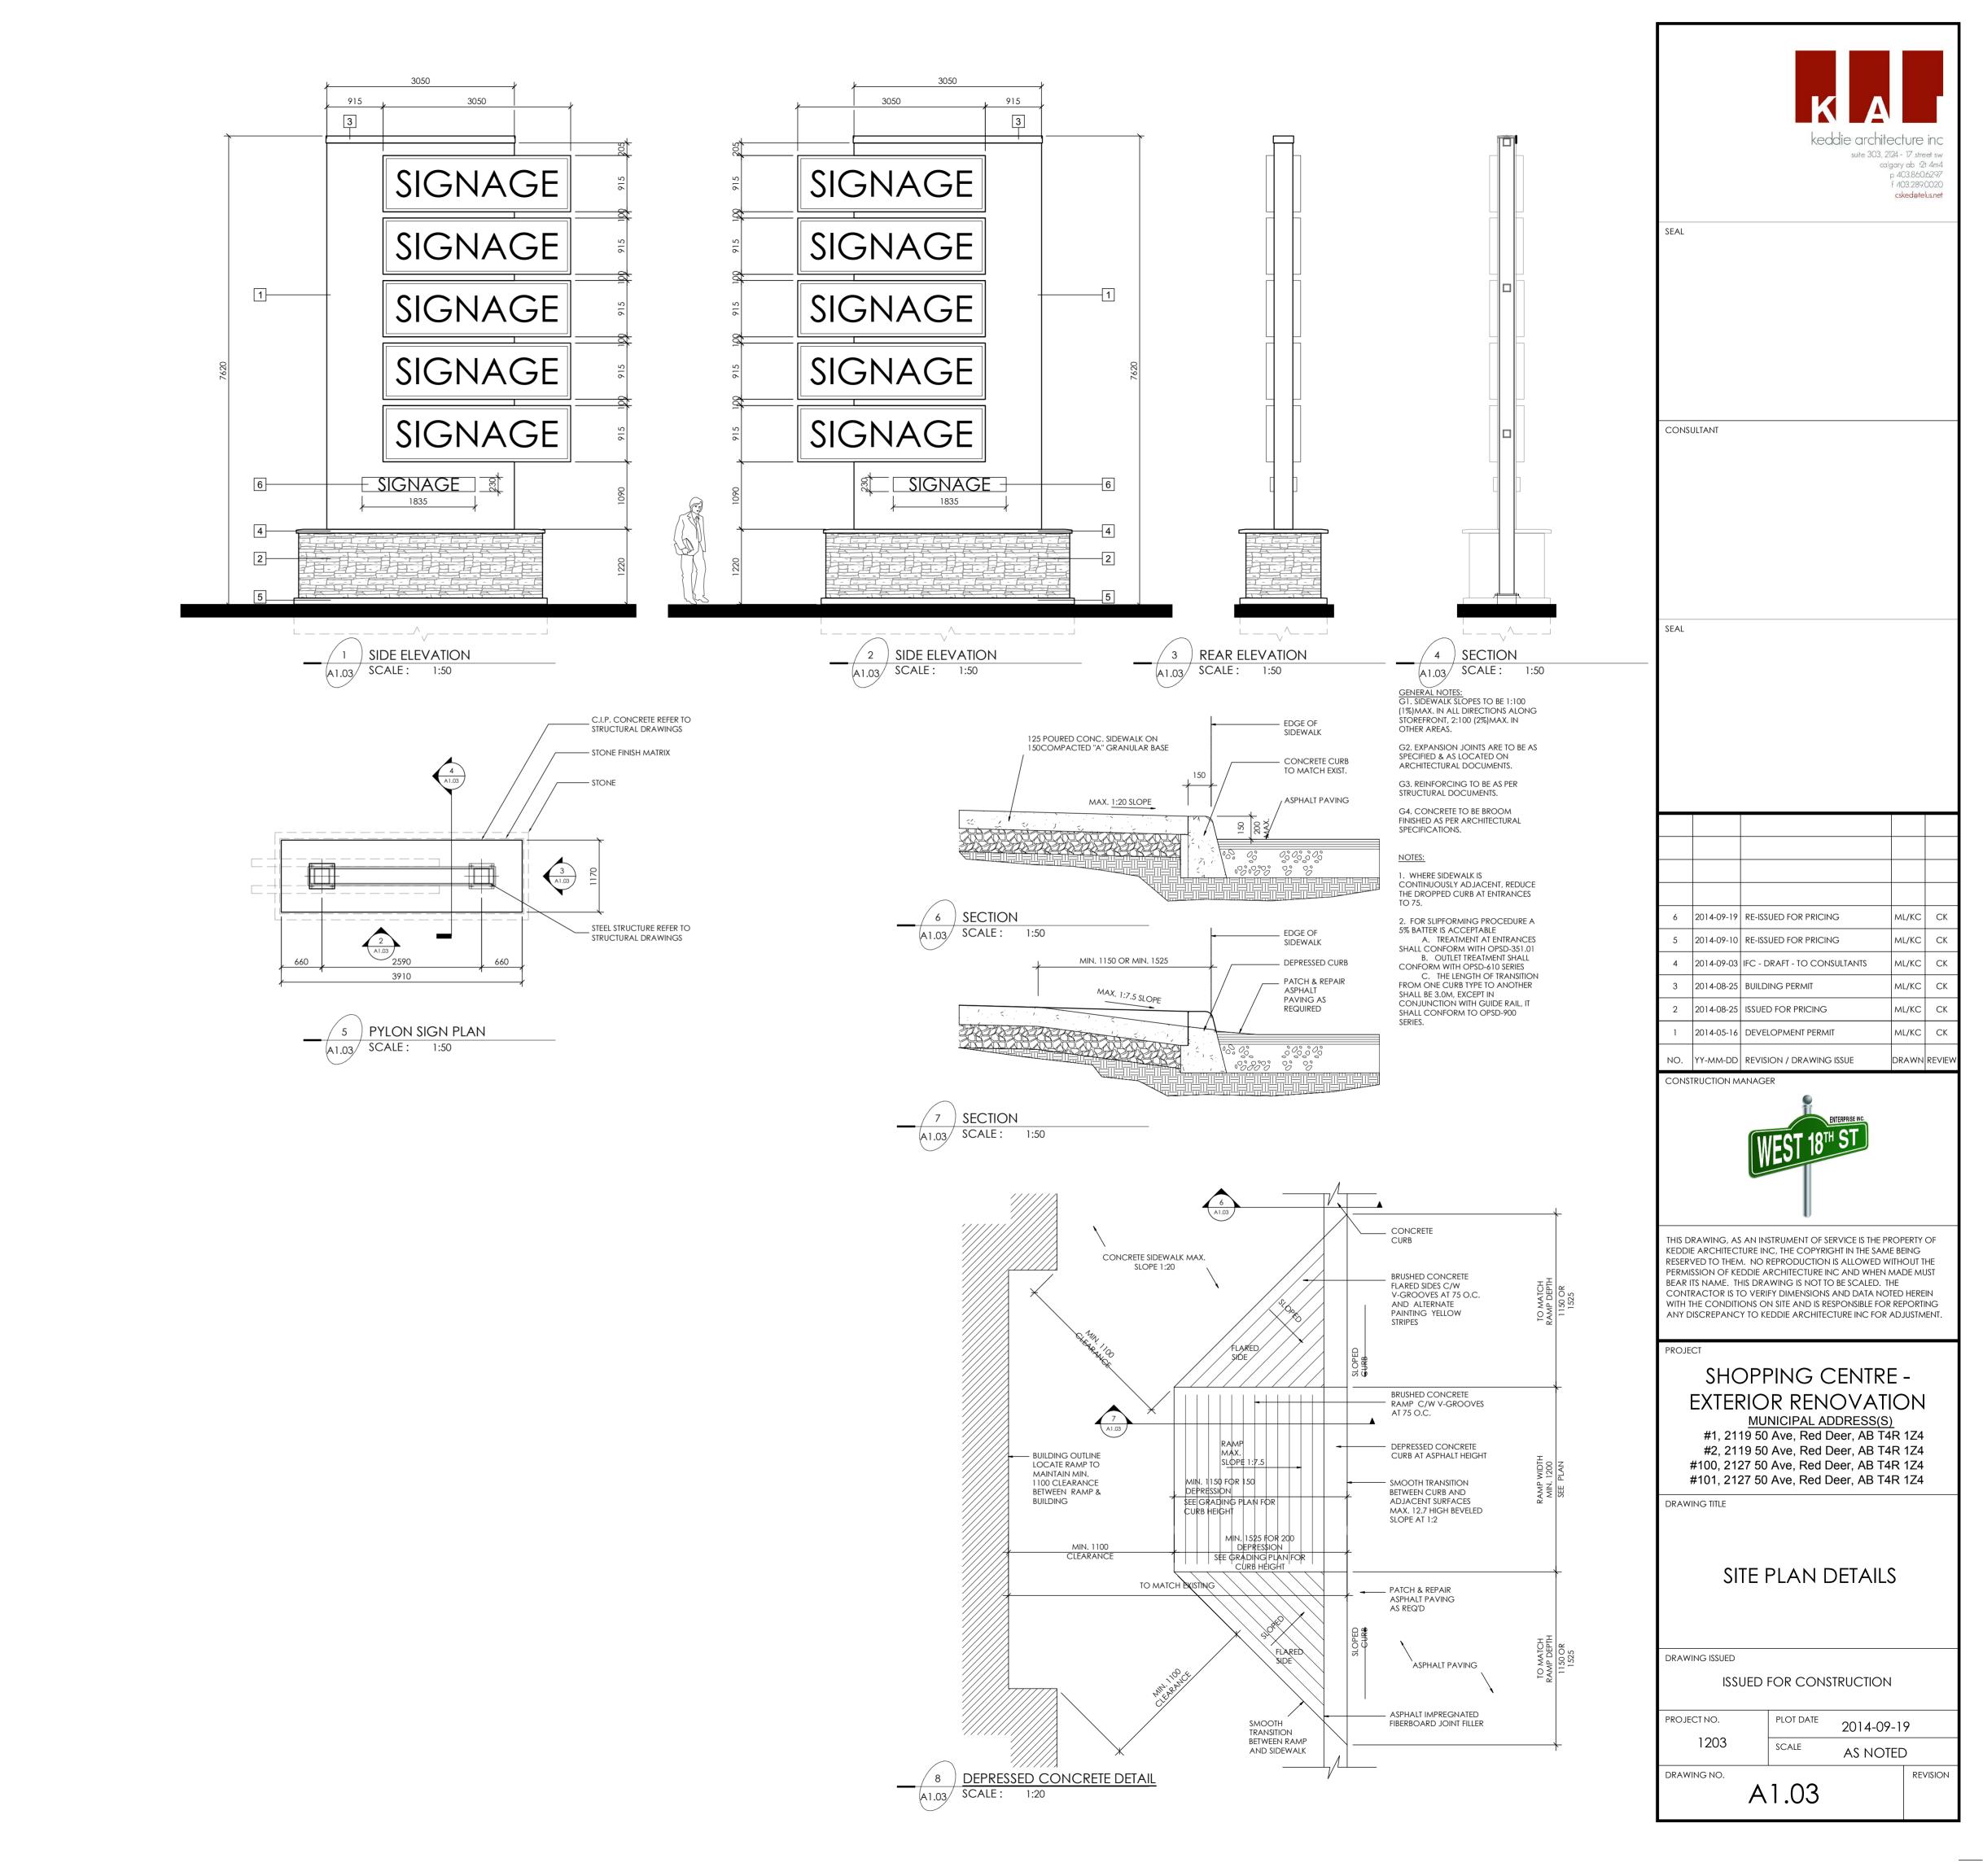

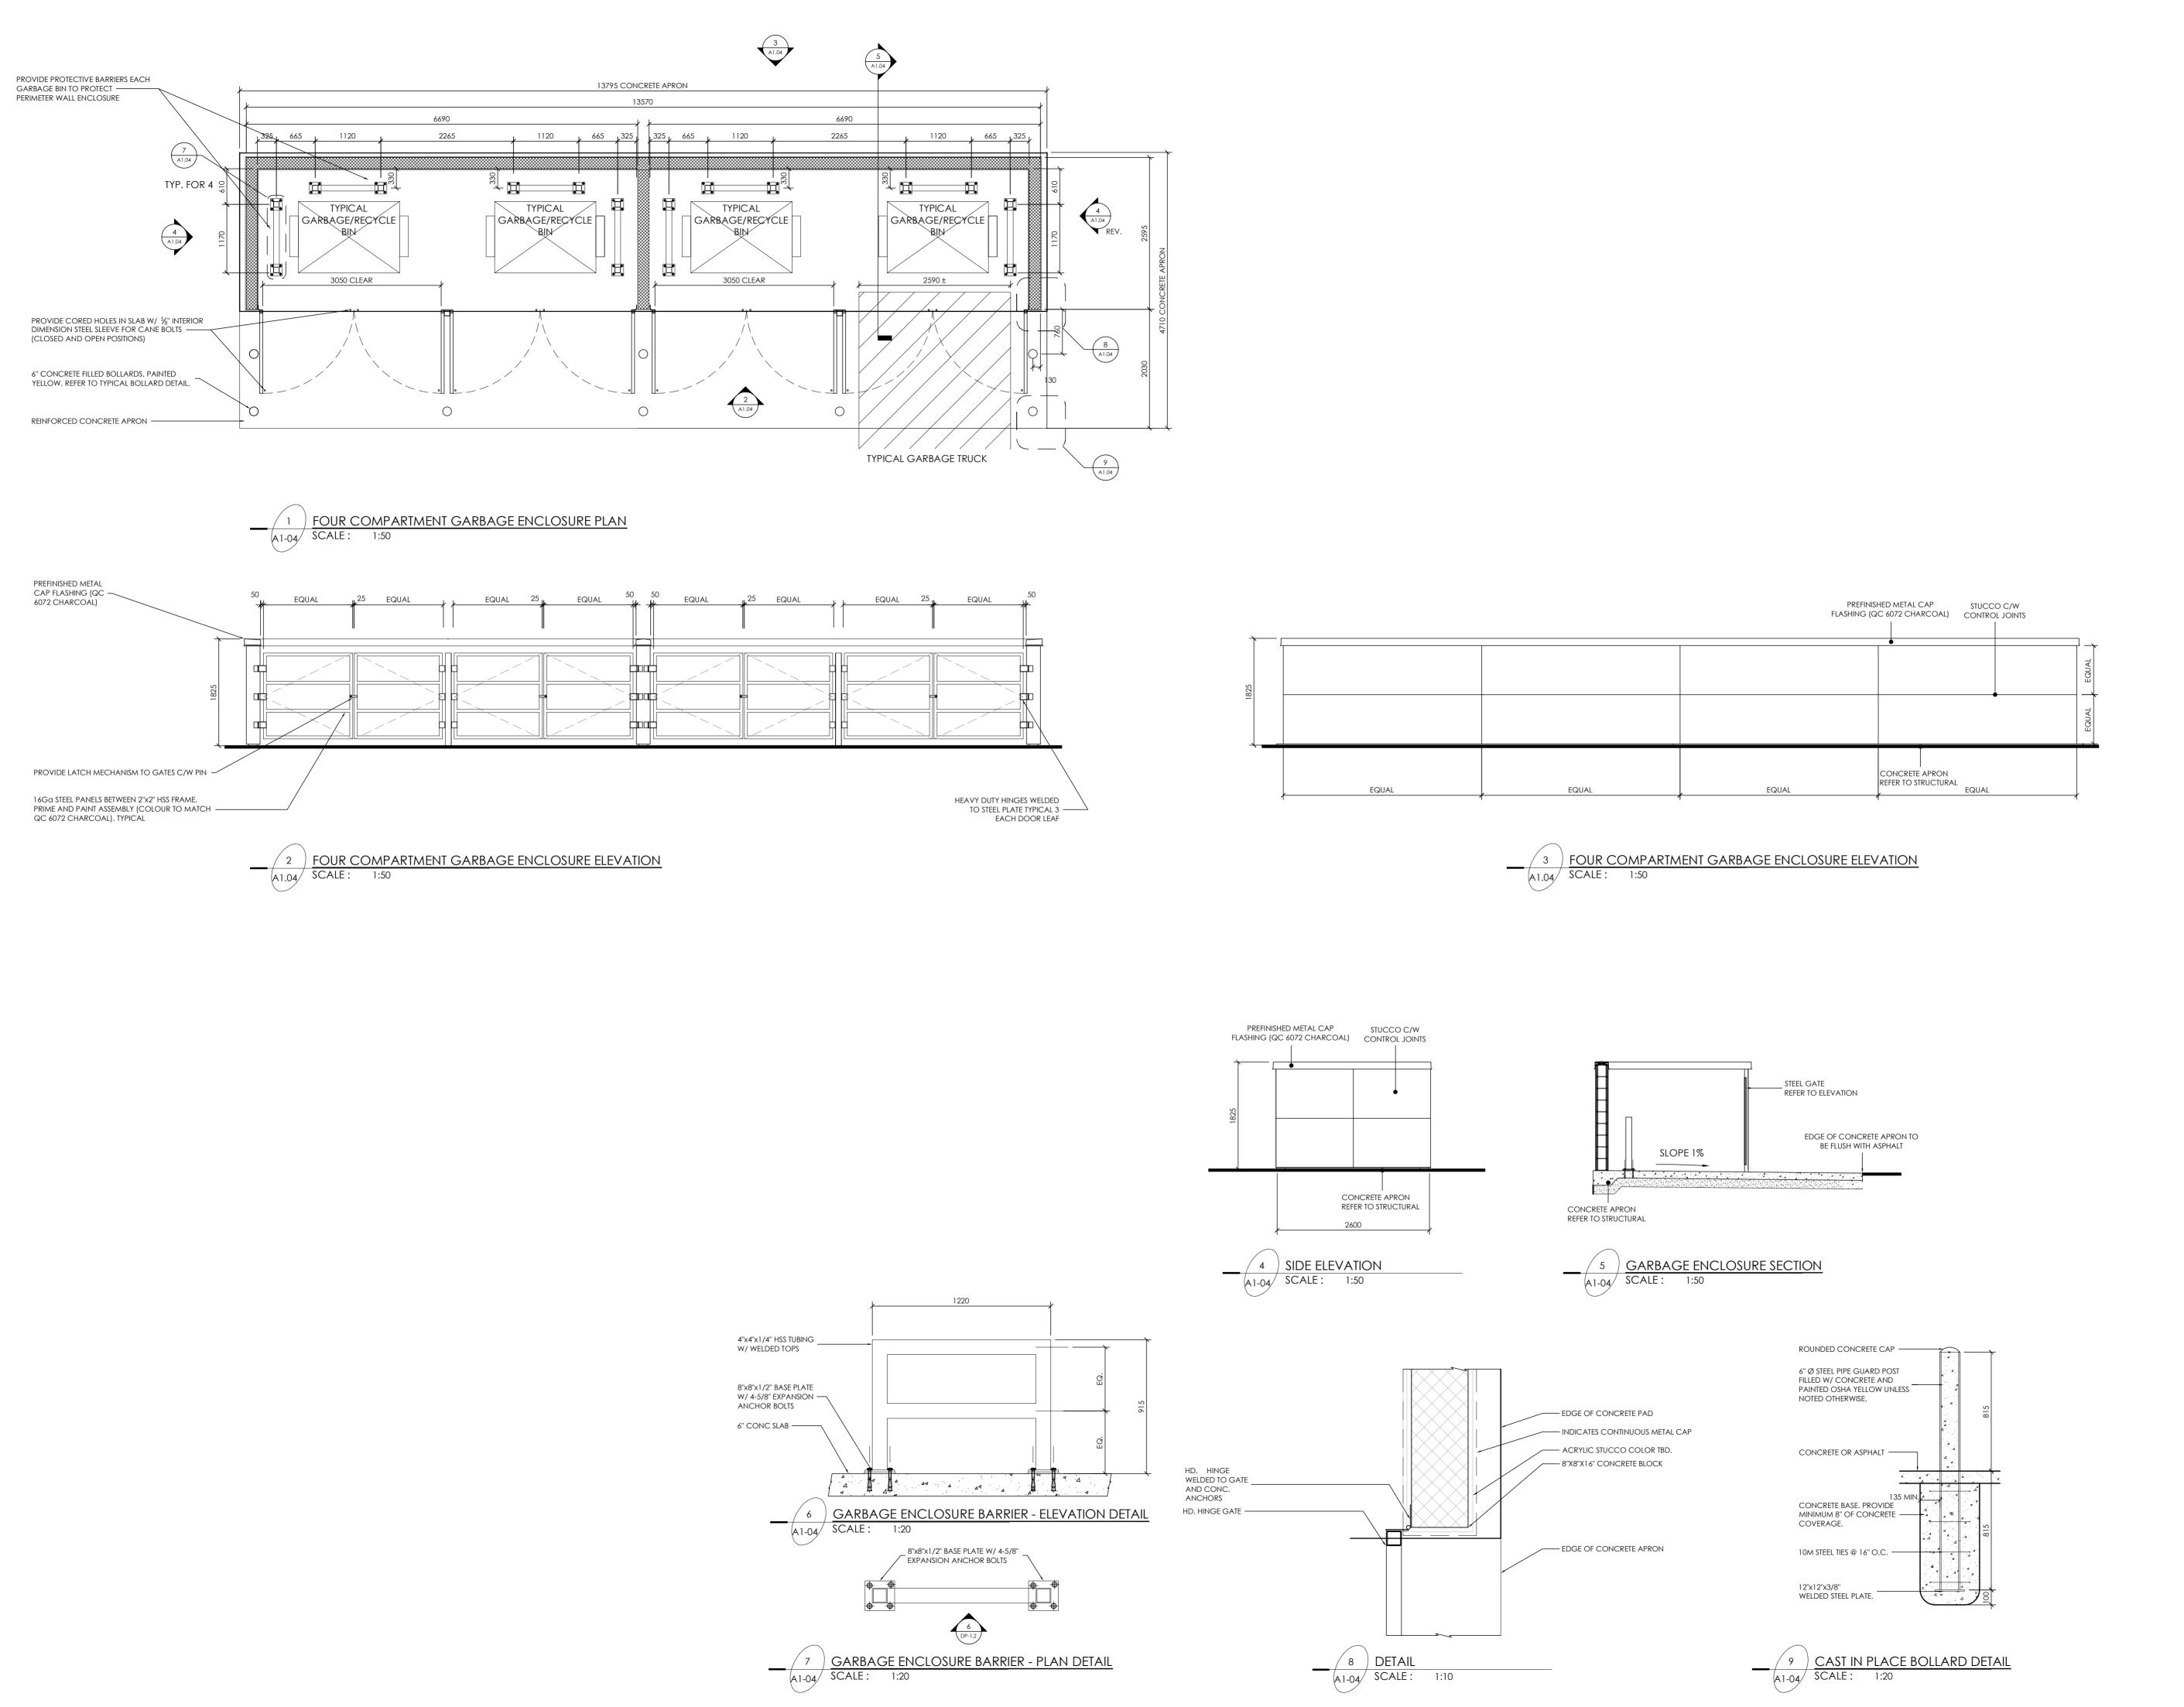

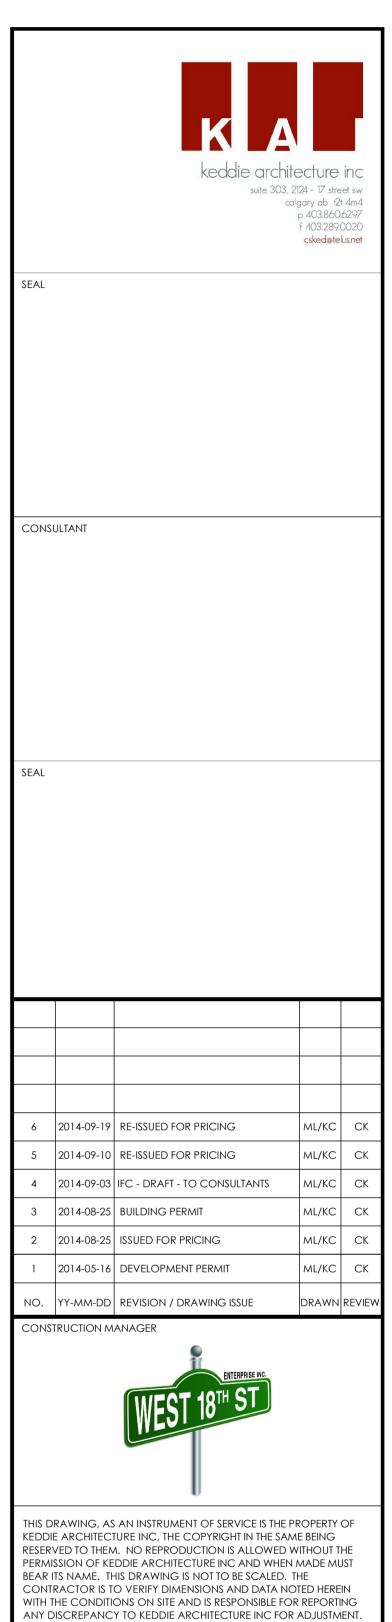

PROJECT

SHOPPING CENTRE - EXTERIOR RENOVATION

MUNICIPAL ADDRESS(S) #1, 2119 50 Ave, Red Deer, AB T4R 1Z4 #2, 2119 50 Ave, Red Deer, AB T4R 1Z4 #100, 2127 50 Ave, Red Deer, AB T4R 1Z4 #101, 2127 50 Ave, Red Deer, AB T4R 1Z4

DRAWING TITLE

SITE PLAN DETAILS GARBAGE ENCLOSURE DETAILS

DRAWING ISSUED

ISSUED FOR CONSTRUCTION

PROJECT NO. PLOT DATE 2014-09-19
1203 SCALE AS NOTED

DRAWING NO.

A1.04

REVISION

