# VISIONS ELECTRONICS

# EMERALD HILLS CENTRE INTERIOR FIT-OUT

### DRAWING LIST:

ARCHITECTURAL		MECHANICAL		ELECTRICAL	
A-0.0	COVER SHEET, DRAWING LIST, KEY PLAN	M2-1	HVAC FLOOR PLANS + MECHANICAL	E1	SPECIFICATIONS
	AND BUILDING CODE SUMMARY		SCHEDULES	E2	EXISTING BASE BUILDING POWER
A-1.0	PARTITION PLAN	M2-2	PLUMBING, DRAINAGE + SPRINKLER	E3	VISIONS TENANT POWER PLAN
A-2.0	REFLECTED CEILING PLAN		FLOOR PLANS + MECHANICAL	E4	VISIONS TENANT LIGHTING PLAN
A-3.0	MEZZANINE PARTITION PLAN +		SCHEDULES		
	REFLECTED CEILING PLAN	M2-3	HVAC FLOOR PLANS + MECHANICAL		
			SPECIFICATION		


## CONSULTANTS.

E-MAIL: csked@telus.net

CONSULIAINIS	•	
ARCHITECTURAL	MECHANICAL	ELECTRICAL
KEDDIE ARCHITECTURE INC	DMH DESIGNS LTD.	R. LAMONTAGNE. P. ENG.
303, 2124 - 17th Street SW	117 Royal Oak Green NW	P.O. Box 2531
Calgary, Alberta	Calgary, Alberta	Didsbury, Alberta
T2T 4M4	T7G 6A7	TOM OWO
CONTACT: CORINNE KEDDIE	CONTACT: DAVID PEDERSEN	CONTACT: RICHARD LAMONTAGNE
TEL: 403.860.6297	TEL: 403.620.3170	TEL: 403.703.6161

EMAIL: dmhdes@shaw.ca

# SYMBOL LEGEND ROOM NAME ROOM IDENTIFICATION P# PARTITION TYPE DOOR TYPE MILLWORK TYPE KEY NOTE CEILING HEIGHT A.F.F. HARDWARE / WC ACCESSORY DETAIL / ELEVATION REFERENCE SECTION MARK REVISION MARK —— ELEVATION INDICATOR

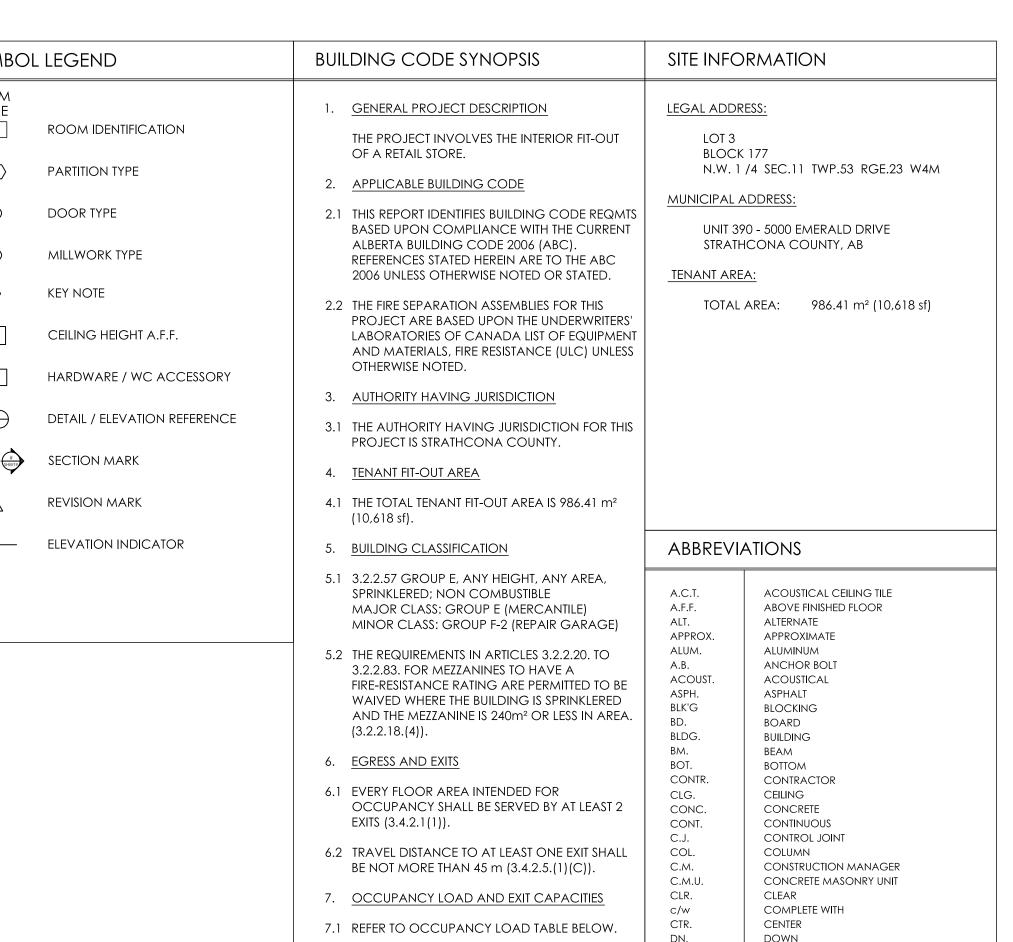

7.2 THE EXIT CAPACITY BASED ON 1-914mm DOOR

IS: 914 / 6.1 PER PERSON = 150 MAXIMUM

TOTAL EXIT WIDTH REQUIRED = 1309.30 mm

TOTAL EXIT WIDTH PROVIDED = 3656.00 mm

8.1 EVERY DOOR THAT PROVIDES A BARRIER-FREE

PATH OF TRAVEL THROUGH AN ENTRANCE...

SHALL BE EQUIPPED WITH A POWER DOOR

ACTIVATE THE OPENING OF THE DOOR FROM

EITHER SIDE FOR A MERCANTILE OCCUPANCY GREATER THAN 500m<sup>2</sup> IN AREA (3.8.3.3.(5).(c))

OPERATOR THAT ALLOWS PERSONS TO

8.2 CONTROLS INTENDED FOR OPERATION BY

8.2 APPROPRIATE SIGNS WILL BE PROVIDED

8.3 EVERY DOOR IN A BARRIER-FREE PATH OF

THAN 800mm IN THE OPEN POSITION

FACILITIES (3.8.3.1.)

(3.8.3.3.(10)).

OCCUPANTS WILL BE MOUNTED BETWEEN

400mm AND 1200mm ABOVE THE FLOOR

INDICATING LOCATIONS OF BARRIER-FREE

TRAVEL WILL HAVE A CLEAR WIDTH OF NOT LESS

THAT DOES NOT REQUIRE TIGHT GRASPING AND

TWISTING OF THE WRIST AS THE ONLY MEANS OF

(3.8.3.3.(1)). DOOR HARDWARE IN A BARRIER-

FREE PATH OF TRAVEL WILL BE OF A DESIGN

OPERATION (3.8.3.3.(3)). CLOSERS ON THE

CLOSING TIME (3.8.3.3.(9)). EXCEPT WITHIN

INTERIOR DOORS IN A BARRIER-FREE PATH OF

TRAVEL WILL HAVE A CLEAR SPACE BEYOND

THE LATCH SIDE OF 600mm WHERE THE DOOR

SWINGS TOWARD THE APPROACH SIDE, AND

300mm WHERE THE DOOR SWINGS AWAY

DESIGNED ACCORDING TO (3.8.3.8., 3.8.3.9.,

69.10 m<sup>2</sup> | 46 m<sup>2</sup>/person

706.11 m<sup>2</sup> | 3.7 m<sup>2</sup>/person |

AREA/PERSON

190.84

18.16

214.64

214.64

107.32

107.32

8.4 A BARRIER-FREE WASHROOM SHALL BE


3.8.3.10., 3.8.3.11. AND 3.8.3.12.).

TRAVEL WILL INCLUDE A DELAYED (3 SECOND)


CAPACITY PER DOOR.

7.3 FOR VISIONS ELECTRONICS:

8. BARRIER-FREE CONSTRUCTION

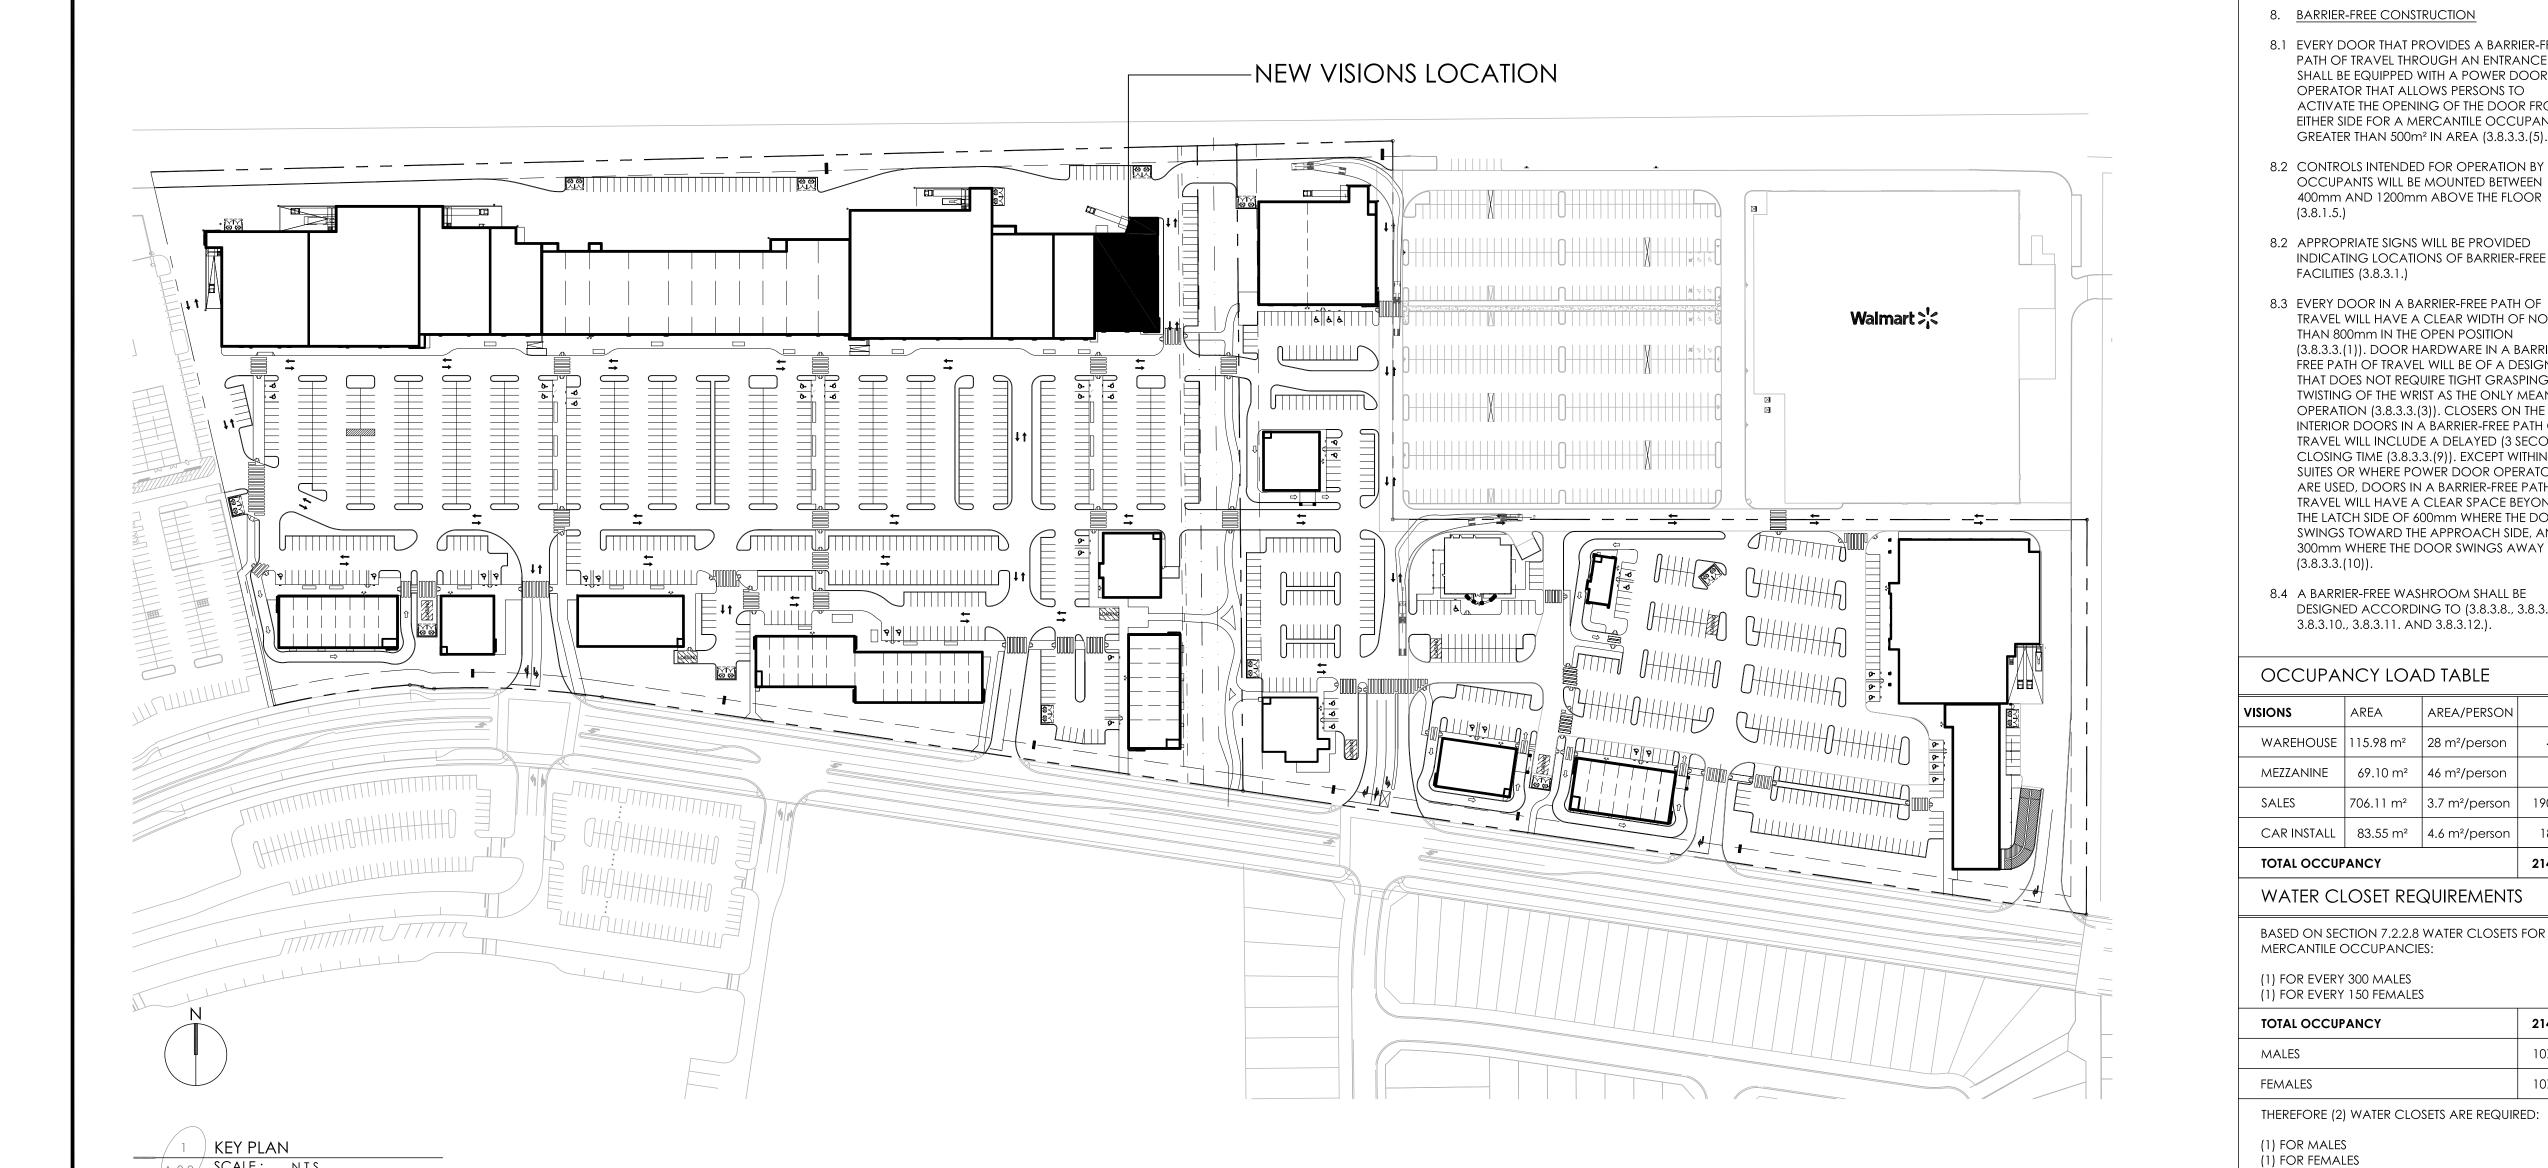

EMAIL: ralamont@shaw.ca

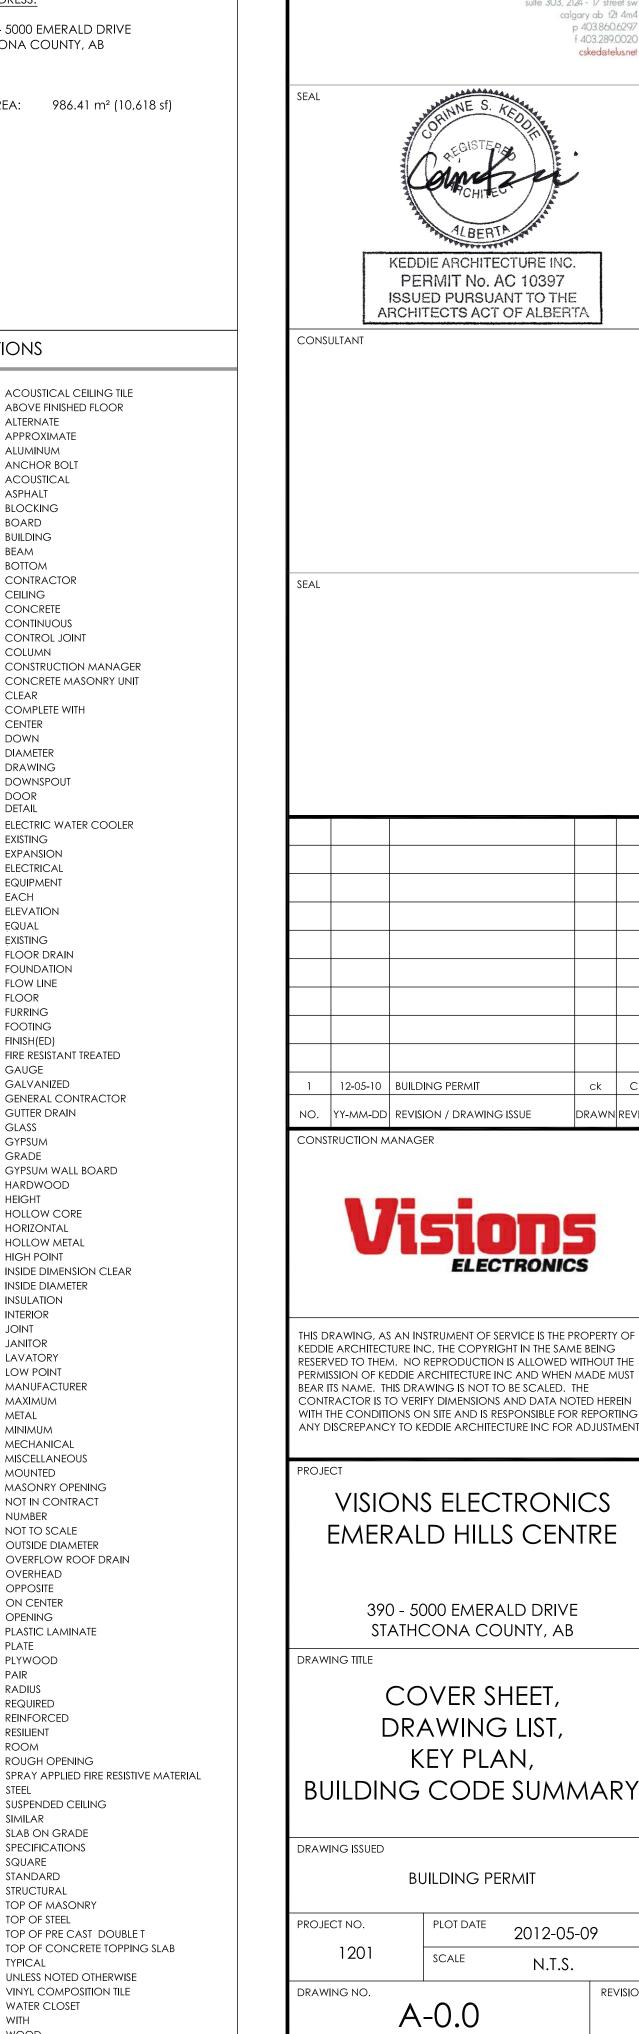

2012-05-09

N.T.S.

REVISIO1

DIAMETER

DRAWING

DOOR

FXISTING

**EXPANSION** ELECTRICAL

**EQUIPMENT** 

ELEVATION

EQUAL

EXISTING FLOOR DRAIN

FOUNDATION

FLOW LINE

FURRING FOOTING

FINISH(ED)

GAUGE GALVANIZED

GLASS

GYPSUM GRADE

GUTTER DRAIN

HARDWOOD

**HOLLOW CORE** HORIZONTAL

HOLLOW METAL

INSIDE DIAMETER

HIGH POINT

INSULATION

INTERIOR

JANITOR

LAVATORY

LOW POINT

MAXIMUM

MINIMUM

MECHANICAL

MISCELLANEOUS

MASONRY OPENING

NOT IN CONTRACT

OUTSIDE DIAMETER OVERFLOW ROOF DRAIN

PLASTIC LAMINATE

NOT TO SCALE

OVERHEAD

OPPOSITE ON CENTER

OPENING

PLYWOOD

REQUIRED REINFORCED

RESILIENT ROOM

**ROUGH OPENING** 

SUSPENDED CEILING

SLAB ON GRADE

SPECIFICATIONS

SQUARE Standard

STRUCTURAL TOP OF MASONRY

TOP OF STEEL

WATER CLOSET

WOOD

TOP OF PRE CAST DOUBLE T

UNLESS NOTED OTHERWISE VINYL COMPOSITION TILE

TOP OF CONCRETE TOPPING SLAB

METAL

MANUFACTURER

FIRE RESISTANT TREATED

GENERAL CONTRACTOR

GYPSUM WALL BOARD

INSIDE DIMENSION CLEAR

DOWNSPOUT

ELECTRIC WATER COOLER

DWG.

DTL/DET.

EXIST.

EQUIP.

G.W.B.

МЕСН.

MISC.

SUSP. CLG.

S.O.G.

SPEC'S.


STRUCT.


ELEV.

suite 303, 2124 - 17 street s

calgary ab t2t 4m p 403.860.629

f 403.289.0020

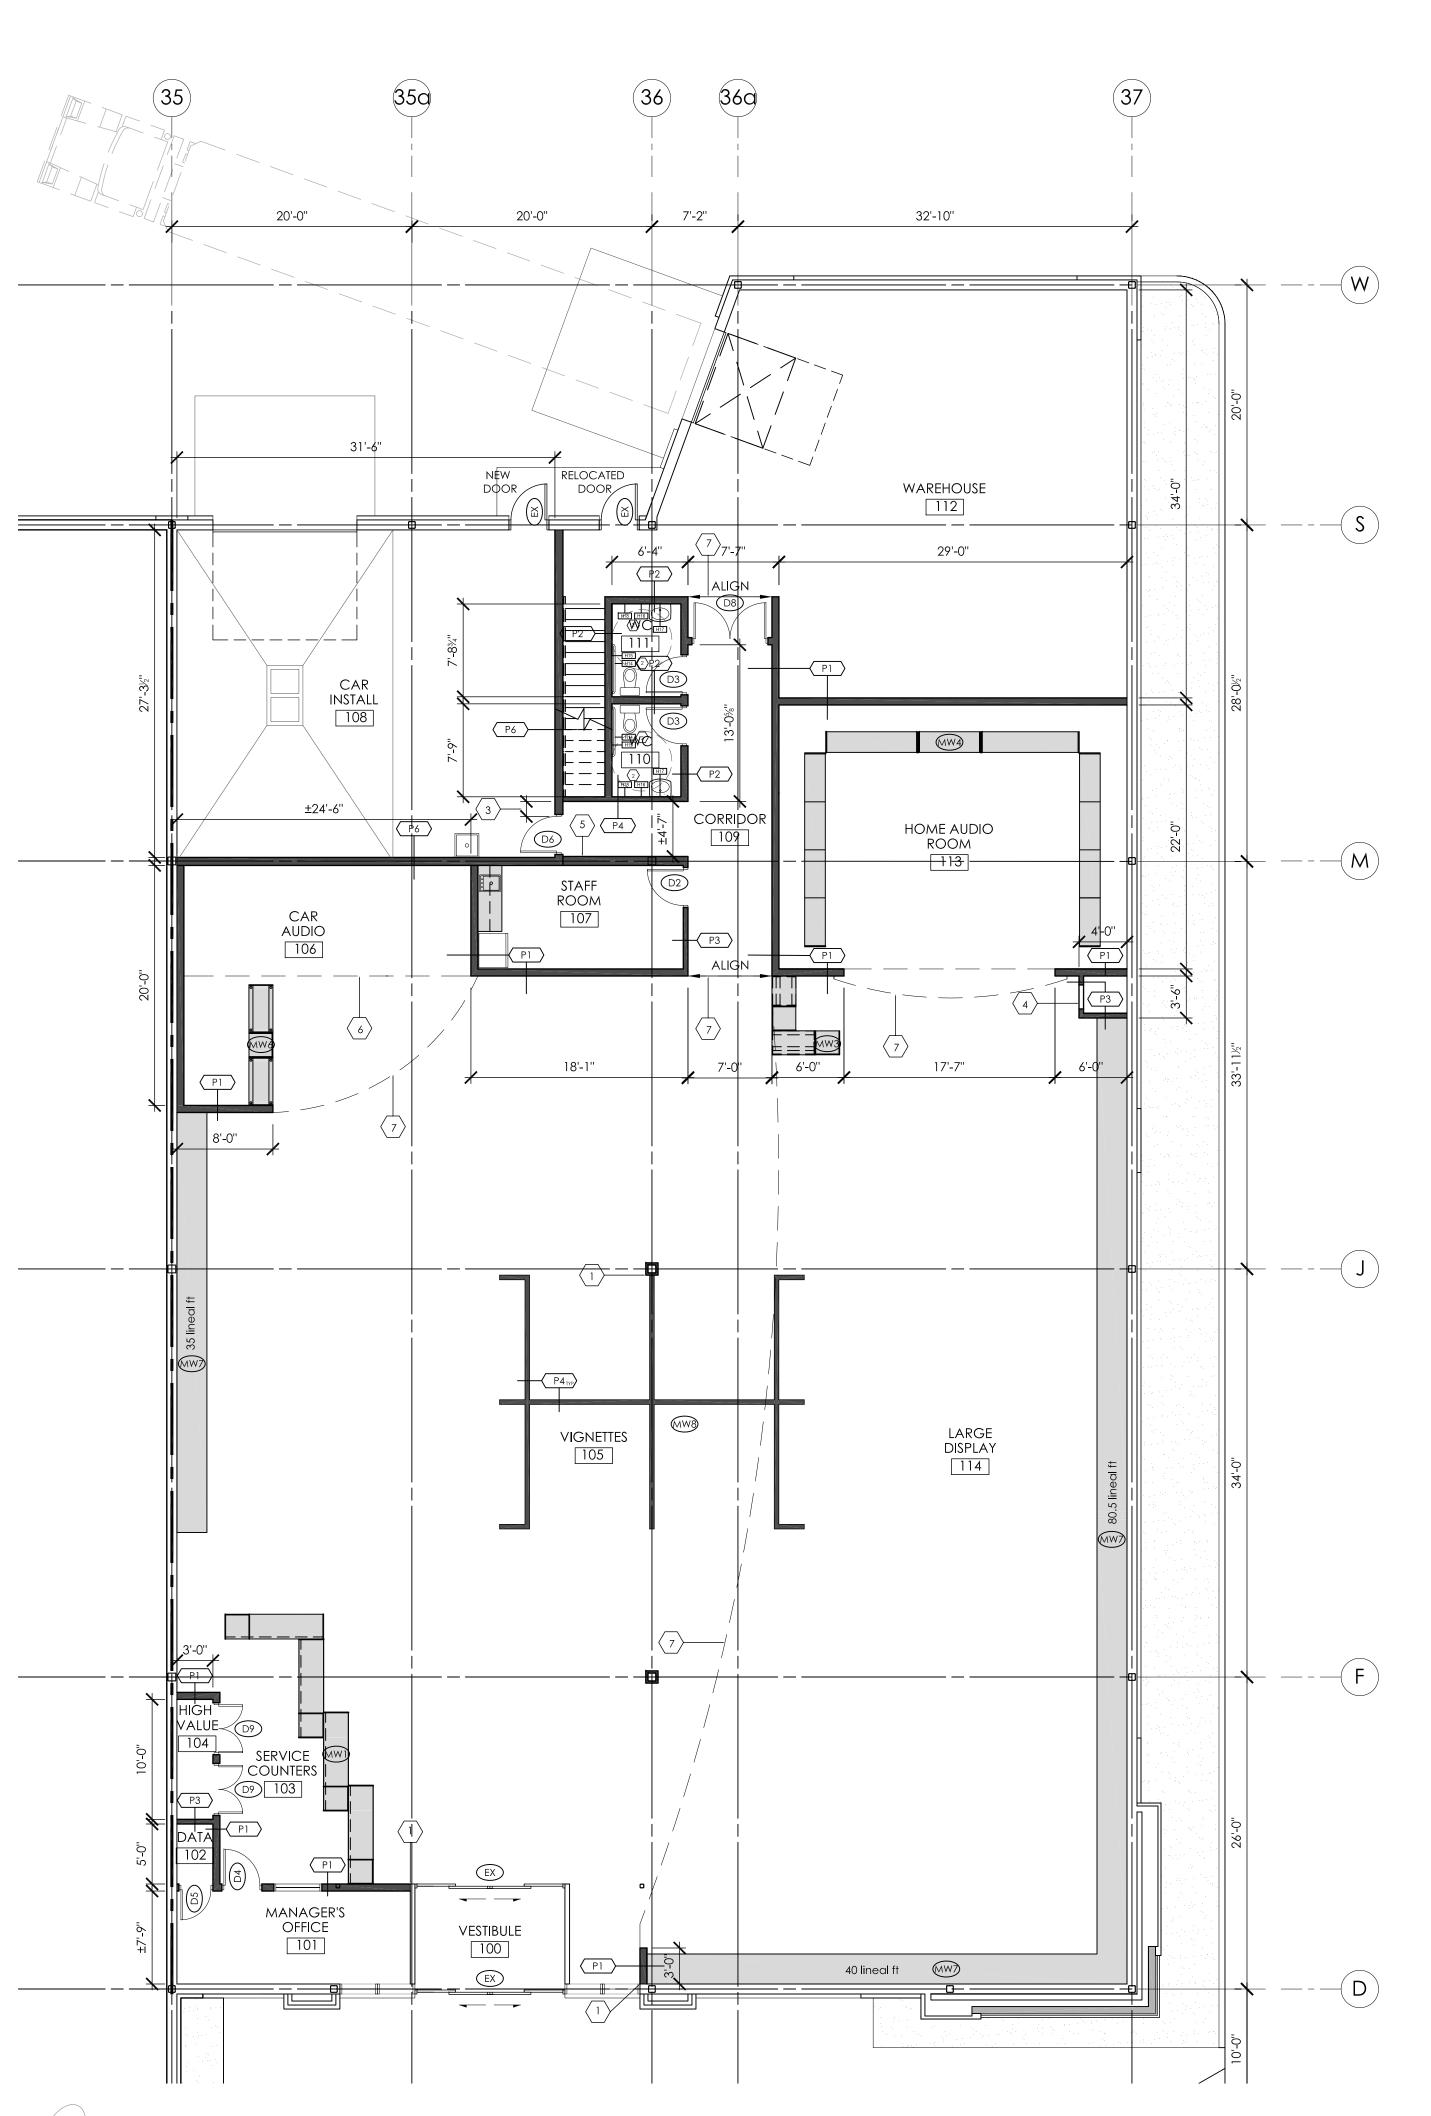

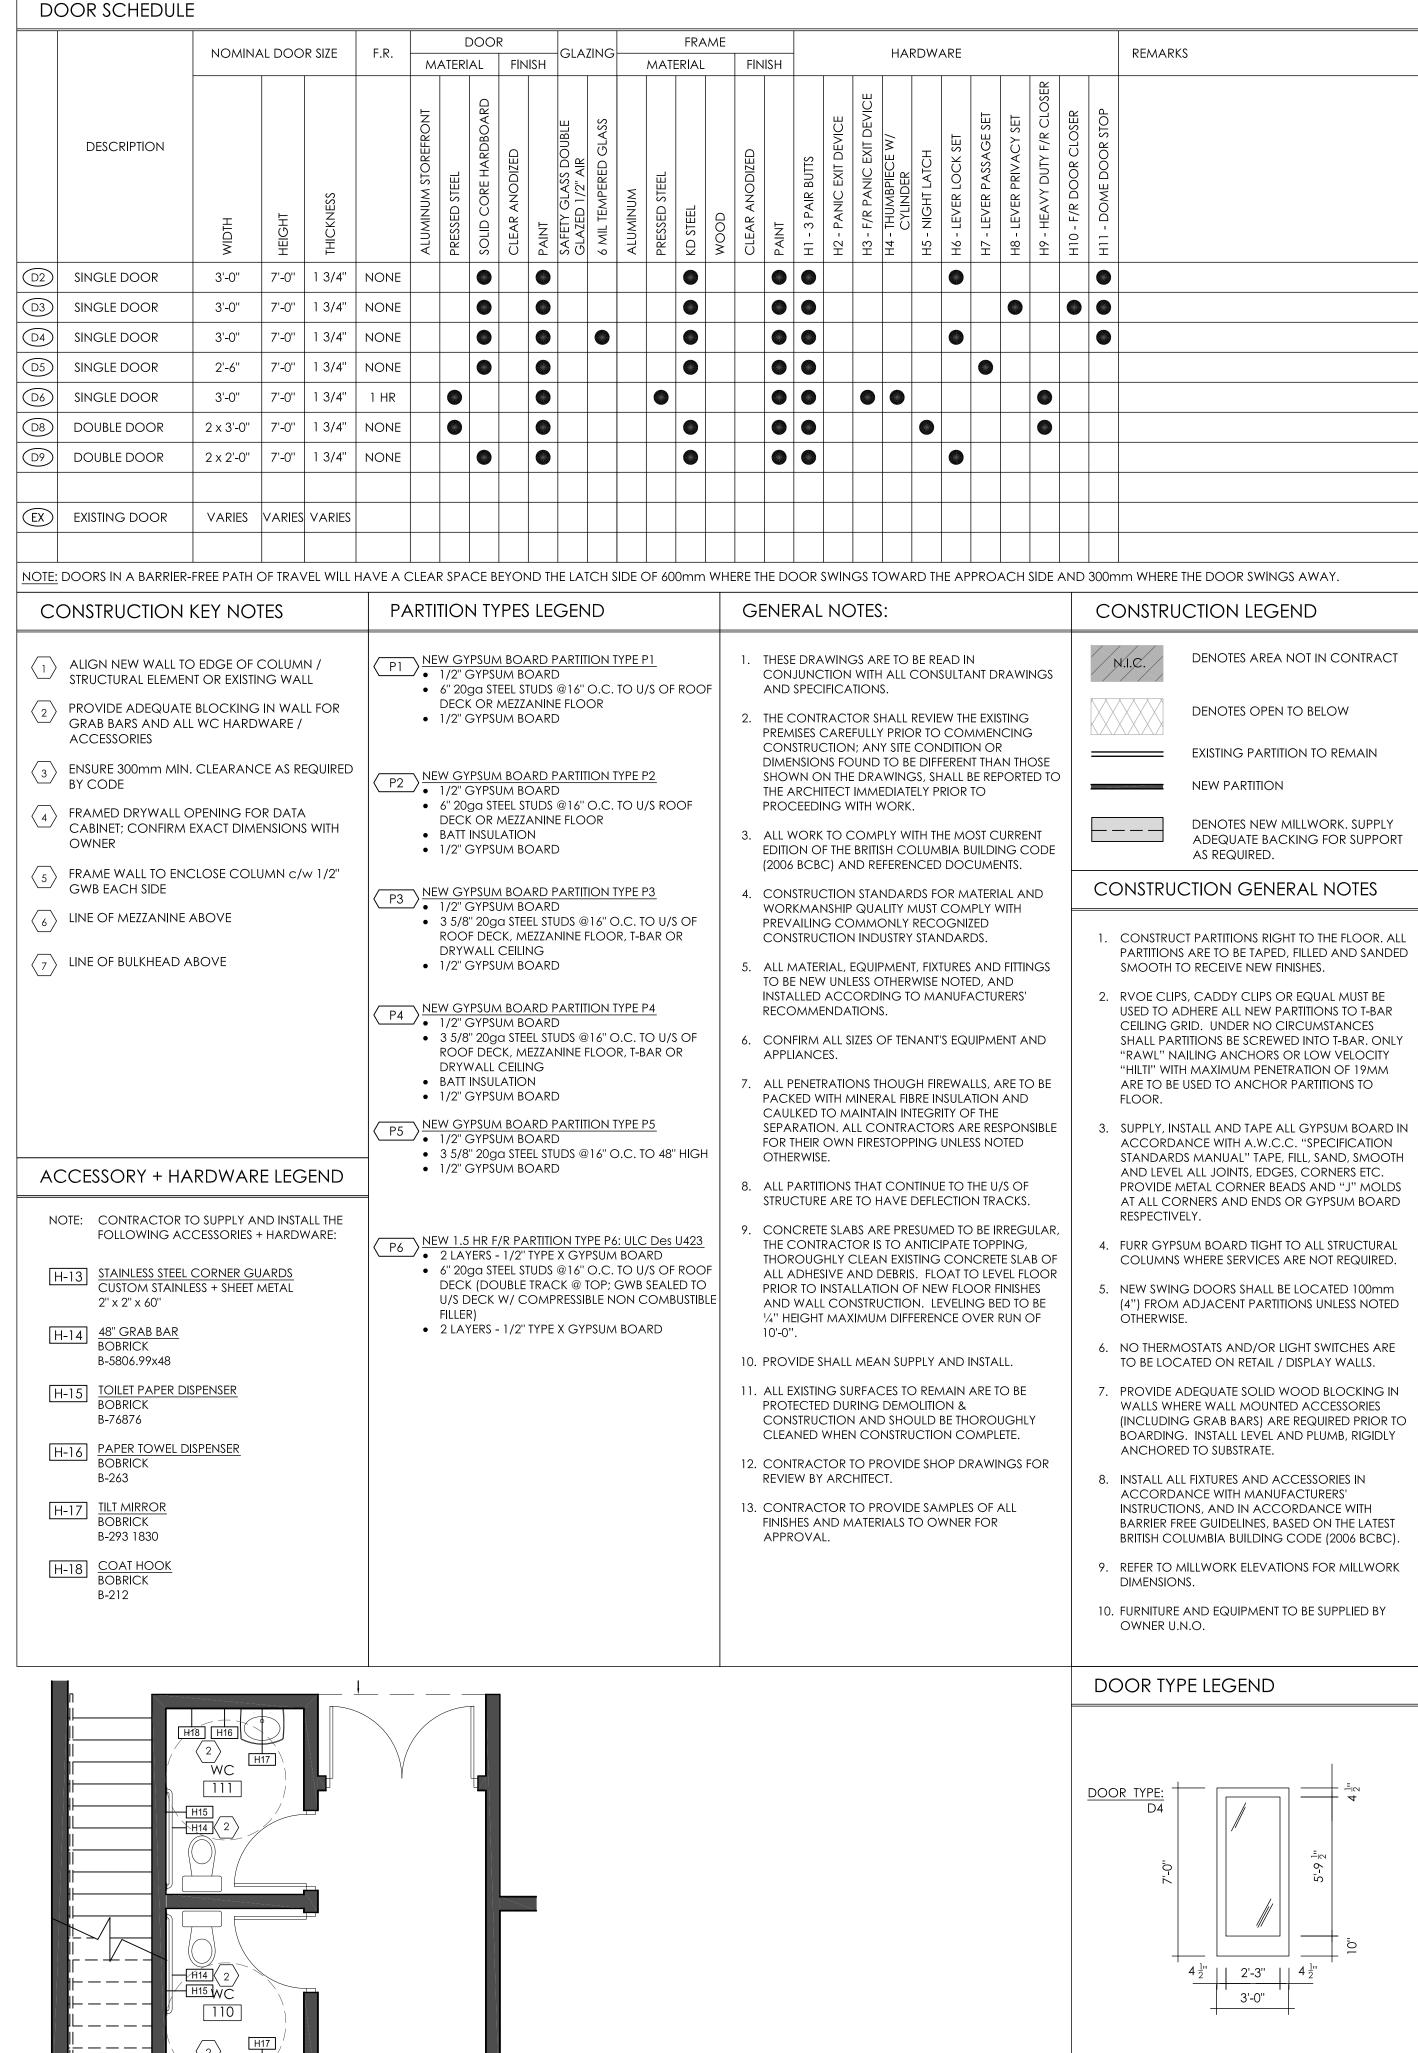



p 403.860.6297 f 403.289.0020 csked@telus.net

KEDDIE ARCHITECTURE INC.

PERMIT No. AC 10397 ISSUED PURSUANT TO THE ARCHITECTS ACT OF ALBERTA

CONSULTANT

12-05-10 BUILDING PERMIT NO. YY-MM-DD REVISION / DRAWING ISSUE

CONSTRUCTION MANAGER



THIS DRAWING, AS AN INSTRUMENT OF SERVICE IS THE PROPERTY OF KEDDIE ARCHITECTURE INC, THE COPYRIGHT IN THE SAME BEING RESERVED TO THEM. NO REPRODUCTION IS ALLOWED WITHOUT THE PERMISSION OF KEDDIE ARCHITECTURE INC AND WHEN MADE MUST BEAR ITS NAME. THIS DRAWING IS NOT TO BE SCALED. THE CONTRACTOR IS TO VERIFY DIMENSIONS AND DATA NOTED HEREIN WITH THE CONDITIONS ON SITE AND IS RESPONSIBLE FOR REPORTING ANY DISCREPANCY TO KEDDIE ARCHITECTURE INC FOR ADJUSTMENT

VISIONS ELECTRONICS EMERALD HILLS CENTRE

> 390 - 5000 EMERALD DRIVE STATHCONA COUNTY, AB

DRAWING TITLE

PARTITION PLAN

DRAWING ISSUED


DRAWING NO.

**BUILDING PERMIT** 


PROJECT NO. 2012-05-09 SCALE AS NOTED

A-1.0

WC ACCESSORY/HARDWARE PLAN A-1.0 SCALE: 1/4" = 1'-0"

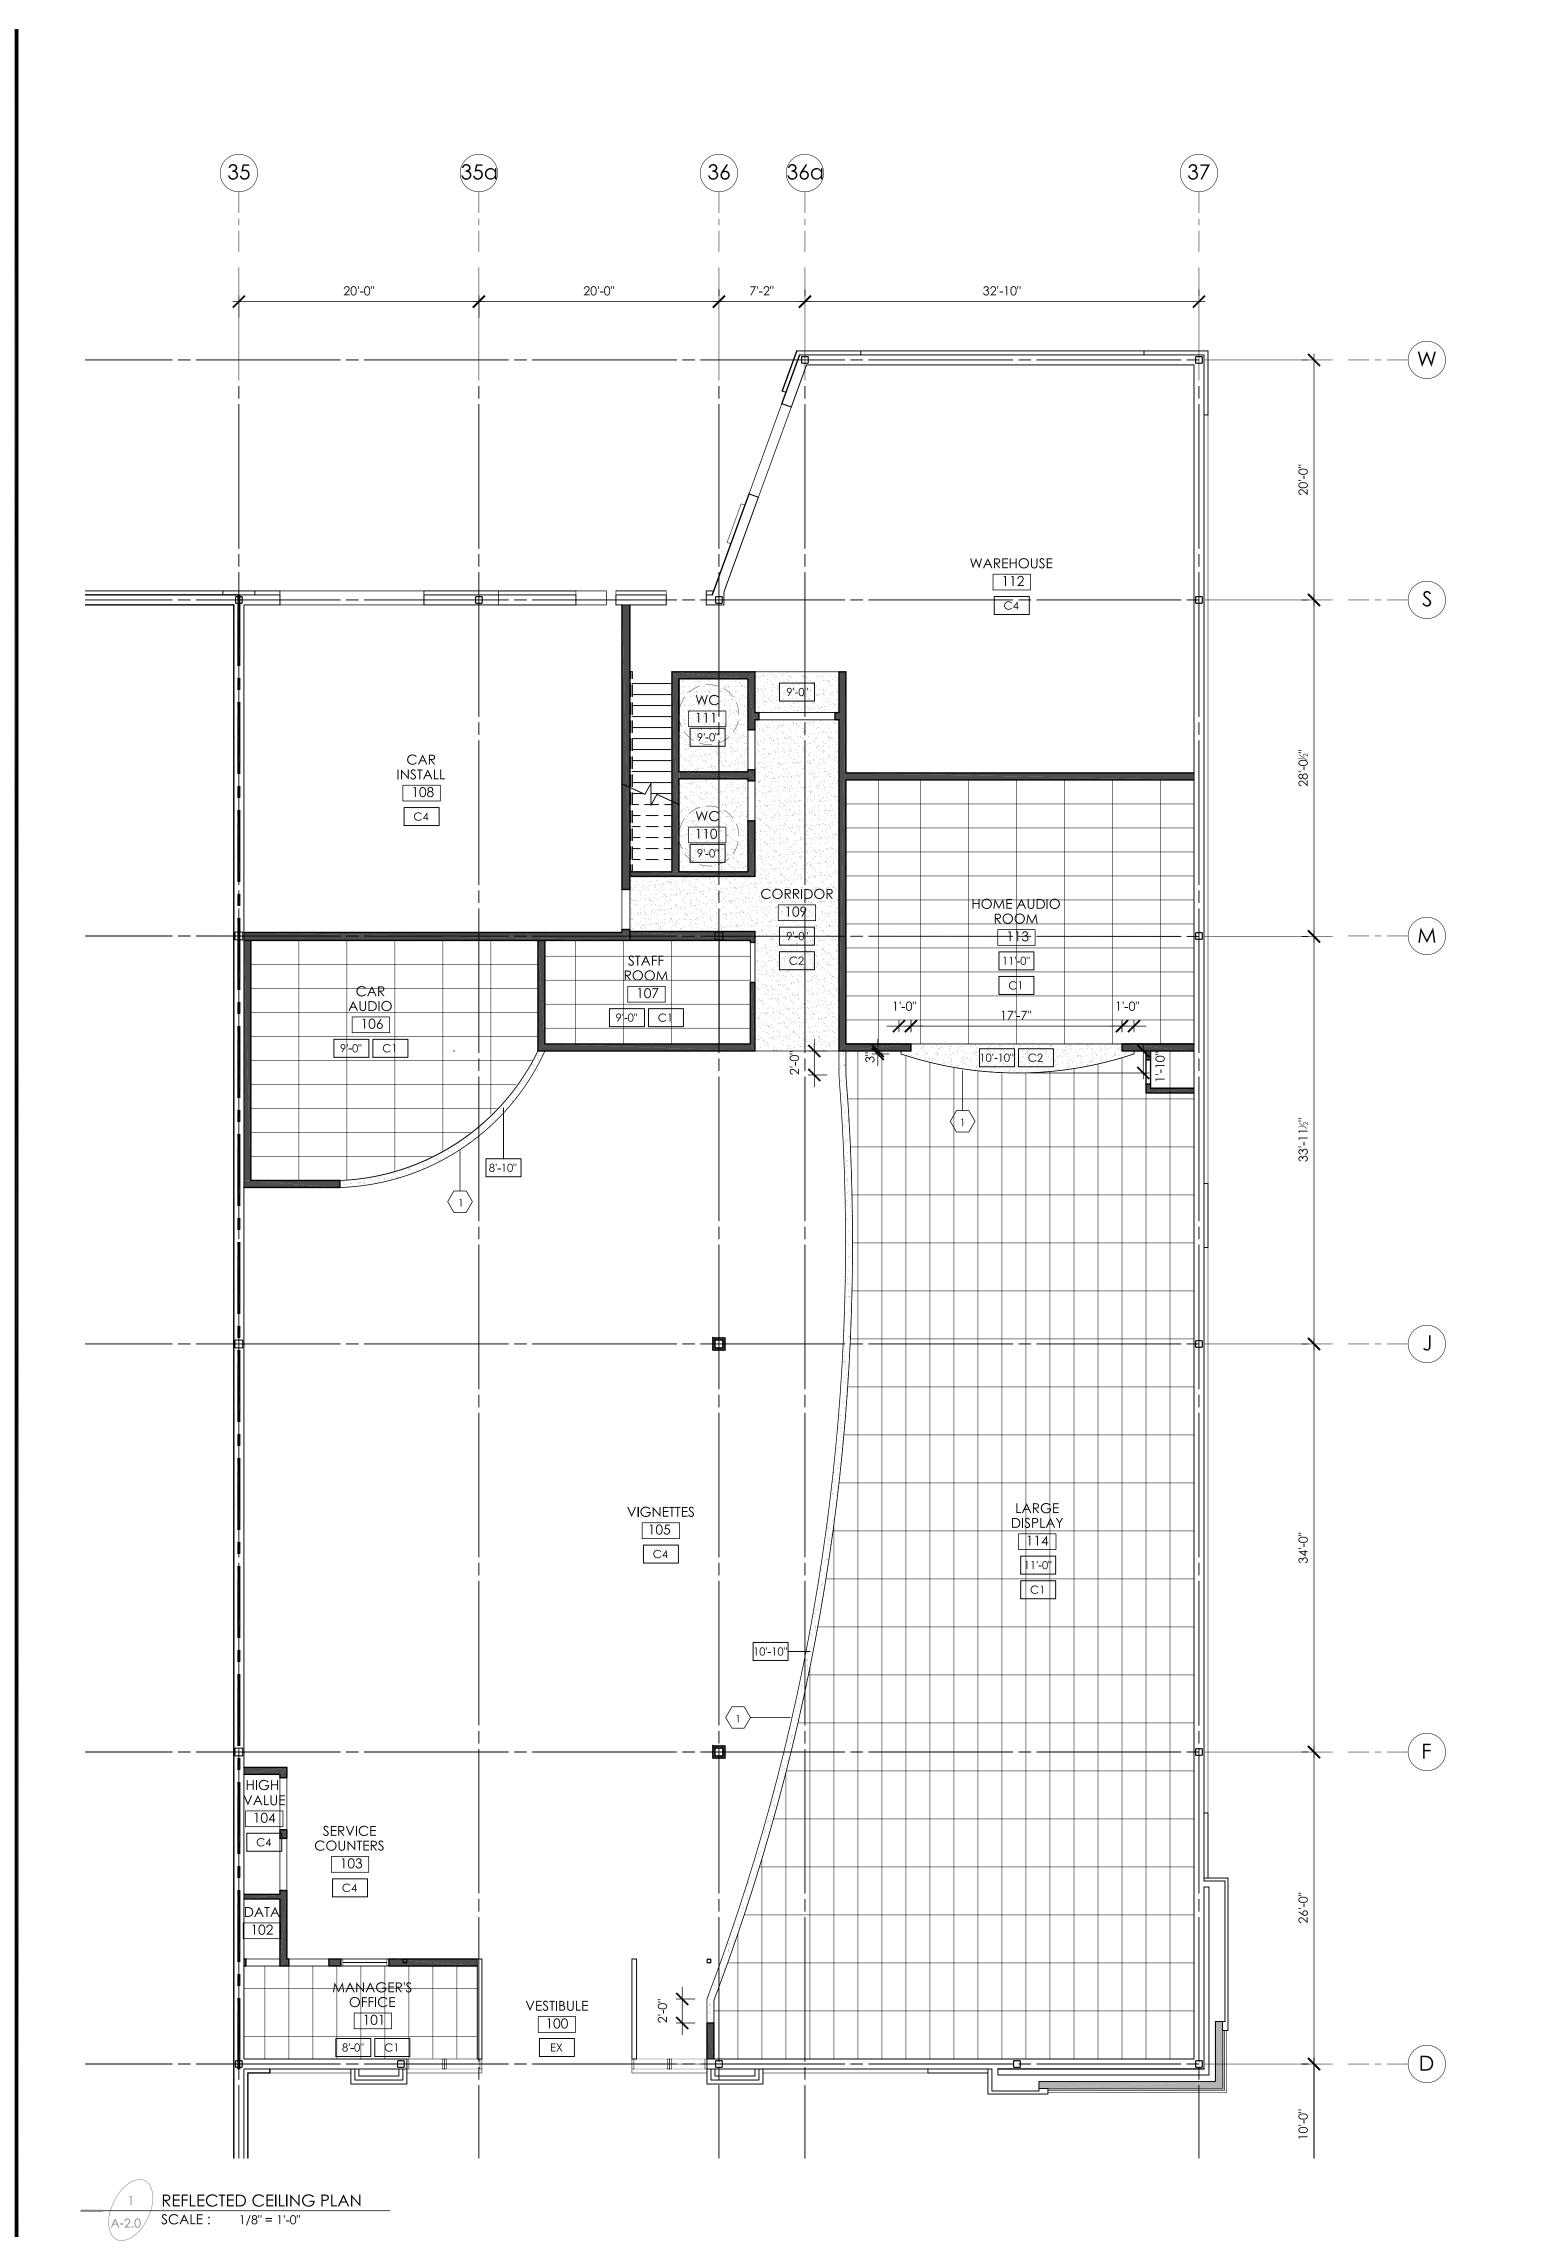

CEILING GENERAL NOTES: CEILING KEY NOTES CEILING TYPE LEGEND NOTE: REFER TO VISIONS SPEC BOOK FOR 1. REFER TO CONSTRUCTION PLANS FOR FURTHER 3 5/8" 20ga STEEL STUDS @16" O.C. C/W 1/2" FINISH REFERENCES POSSIBLE INFORMATION WITH REGARDS TO CEILING GYPSUM WALL BOARD; FACE OF BULKHEAD TO CONSTRUCTION AND FINISHING. EXTEND TO U/S OF ROOF DECK OR T-BAR LINE OF BULKHEAD ABOVE 2. DRYWALL CONTRACTOR TO ALLOW FOR ALL MECHANICAL AND ELECTRICAL PENETRATIONS IN CEILING. C1 NEW 2'X4' SUSPENDED ACOUSTIC CEILING TILE + GRID SYSTEM: 3. CONTRACTOR SHALL PROVIDE DRYWALL ARMSTRONG: CORTEGA #769 CONSTRUCTED ACCESS PANELS COMPLETE WITH PRELUDE XL 15/16" EXPOSED TEE MILLCORE EDGES AND CONCEALED ANGLE MOUNTING (AS REQUIRED / AS PER MECHANICAL DRAWINGS AND SPECIFICATIONS). LOCATION TO C2 NEW GYPSUM BOARD CEILING; BE APPROVED BY DESIGNER. 4. ALL EXPOSED DUCTWORK, AIR DIFFUSERS AND CONDUIT TO BE PAINTED TO MATCH ADJACENT 5. ALL MISCELLANEOUS METALS, TRIMS ON CEILINGS C3 NEW 1-HR FIRE RATED TYPE X ETC., TO BE PAINTED TO MATCH ADJACENT CEILING CEILING; PAINTED 6. PAINT ALL HORIZONTAL AND VERTICAL BULKHEAD FACES TO MATCH FINISH AS NOTED. C4 EXPOSED CEILING STRUCTURE + DECKING; PAINTED INCLUDING ALL EXPOSED METAL AND DUCTWORK CONSULTANT REFERS TO CEILING HEIGHT A.F.F. **GENERAL NOTES:** CONSTRUCTION LEGEND DENOTES AREA NOT IN CONTRACT I. THESE DRAWINGS ARE TO BE READ IN CONJUNCTION WITH ALL CONSULTANT DRAWINGS AND SPECIFICATIONS. DENOTES OPEN TO BELOW 2. THE CONTRACTOR SHALL REVIEW THE EXISTING PREMISES CAREFULLY PRIOR TO COMMENCING CONSTRUCTION; ANY SITE CONDITION OR EXISTING PARTITION TO REMAIN DIMENSIONS FOUND TO BE DIFFERENT THAN THOSE SHOWN ON THE DRAWINGS, SHALL BE REPORTED TO NEW PARTITION THE ARCHITECT IMMEDIATELY PRIOR TO PROCEEDING WITH WORK. DENOTES NEW MILLWORK. SUPPLY 3. ALL WORK TO COMPLY WITH THE MOST CURRENT ADEQUATE BACKING FOR SUPPORT EDITION OF THE BRITISH COLUMBIA BUILDING CODE AS REQUIRED. (2006 BCBC) AND REFERENCED DOCUMENTS. CONSTRUCTION GENERAL NOTES 4. CONSTRUCTION STANDARDS FOR MATERIAL AND WORKMANSHIP QUALITY MUST COMPLY WITH PREVAILING COMMONLY RECOGNIZED CONSTRUCTION INDUSTRY STANDARDS. 1. CONSTRUCT PARTITIONS RIGHT TO THE FLOOR. ALL PARTITIONS ARE TO BE TAPED, FILLED AND SANDED 5. ALL MATERIAL, EQUIPMENT, FIXTURES AND FITTINGS SMOOTH TO RECEIVE NEW FINISHES. to be new unless otherwise noted, and INSTALLED ACCORDING TO MANUFACTURERS' 2. RVOE CLIPS, CADDY CLIPS OR EQUAL MUST BE RECOMMENDATIONS. USED TO ADHERE ALL NEW PARTITIONS TO T-BAR CEILING GRID. UNDER NO CIRCUMSTANCES SHALL PARTITIONS BE SCREWED INTO T-BAR. ONLY 6. CONFIRM ALL SIZES OF TENANT'S EQUIPMENT AND APPLIANCES. "RAWL" NAILING ANCHORS OR LOW VELOCITY "HILTI" WITH MAXIMUM PENETRATION OF 19MM 7. ALL PENETRATIONS THOUGH FIREWALLS, ARE TO BE ARE TO BE USED TO ANCHOR PARTITIONS TO PACKED WITH MINERAL FIBRE INSULATION AND CAULKED TO MAINTAIN INTEGRITY OF THE SEPARATION. ALL CONTRACTORS ARE RESPONSIBLE 3. SUPPLY, INSTALL AND TAPE ALL GYPSUM BOARD IN FOR THEIR OWN FIRESTOPPING UNLESS NOTED ACCORDANCE WITH A.W.C.C. "SPECIFICATION OTHERWISE. STANDARDS MANUAL" TAPE, FILL, SAND, SMOOTH AND LEVEL ALL JOINTS, EDGES, CORNERS ETC. 8. ALL PARTITIONS THAT CONTINUE TO THE U/S OF PROVIDE METAL CORNER BEADS AND "J" MOLDS STRUCTURE ARE TO HAVE DEFLECTION TRACKS. AT ALL CORNERS AND ENDS OR GYPSUM BOARD RESPECTIVELY. 9. CONCRETE SLABS ARE PRESUMED TO BE IRREGULAR 12-05-10 BUILDING PERMIT THE CONTRACTOR IS TO ANTICIPATE TOPPING. 4. FURR GYPSUM BOARD TIGHT TO ALL STRUCTURAL THOROUGHLY CLEAN EXISTING CONCRETE SLAB OF COLUMNS WHERE SERVICES ARE NOT REQUIRED. NO. YY-MM-DD REVISION / DRAWING ISSUE ALL ADHESIVE AND DEBRIS. FLOAT TO LEVEL FLOOR PRIOR TO INSTALLATION OF NEW FLOOR FINISHES 5. NEW SWING DOORS SHALL BE LOCATED 100mm CONSTRUCTION MANAGER AND WALL CONSTRUCTION. LEVELING BED TO BE (4") FROM ADJACENT PARTITIONS UNLESS NOTED 1/4" HEIGHT MAXIMUM DIFFERENCE OVER RUN OF OTHERWISE. 6. NO THERMOSTATS AND/OR LIGHT SWITCHES ARE 10. PROVIDE SHALL MEAN SUPPLY AND INSTALL. TO BE LOCATED ON RETAIL / DISPLAY WALLS. 11. ALL EXISTING SURFACES TO REMAIN ARE TO BE 7. PROVIDE ADEQUATE SOLID WOOD BLOCKING IN PROTECTED DURING DEMOLITION & WALLS WHERE WALL MOUNTED ACCESSORIES CONSTRUCTION AND SHOULD BE THOROUGHLY (INCLUDING GRAB BARS) ARE REQUIRED PRIOR TO BOARDING. INSTALL LEVEL AND PLUMB, RIGIDLY CLEANED WHEN CONSTRUCTION COMPLETE. ANCHORED TO SUBSTRATE. 12. CONTRACTOR TO PROVIDE SHOP DRAWINGS FOR REVIEW BY ARCHITECT. 8. INSTALL ALL FIXTURES AND ACCESSORIES IN ACCORDANCE WITH MANUFACTURERS' 13. CONTRACTOR TO PROVIDE SAMPLES OF ALL INSTRUCTIONS, AND IN ACCORDANCE WITH FINISHES AND MATERIALS TO OWNER FOR BARRIER FREE GUIDELINES, BASED ON THE LATEST APPROVAL. BRITISH COLUMBIA BUILDING CODE (2006 BCBC). 9. REFER TO MILLWORK ELEVATIONS FOR MILLWORK ANY DISCREPANCY TO KEDDIE ARCHITECTURE INC FOR ADJUSTMENT. DIMENSIONS. 10. FURNITURE AND EQUIPMENT TO BE SUPPLIED BY OWNER U.N.O.

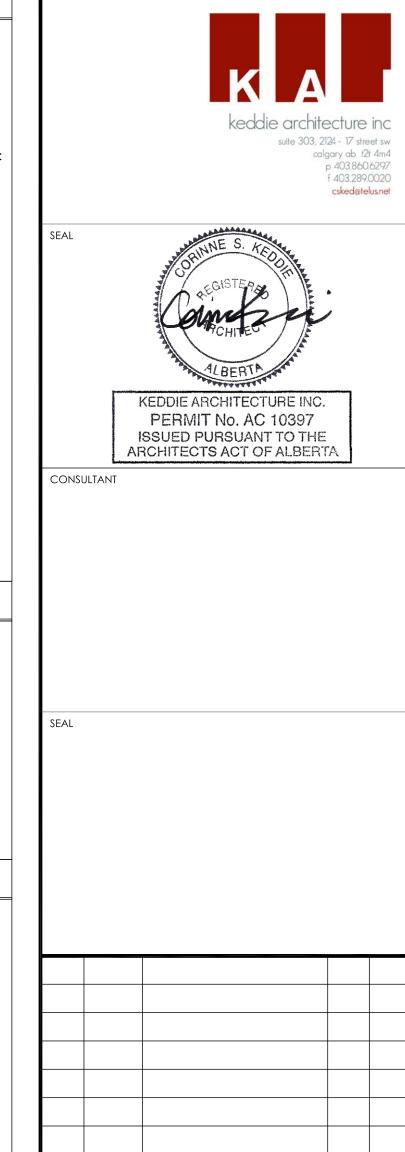



THIS DRAWING, AS AN INSTRUMENT OF SERVICE IS THE PROPERTY OF KEDDIE ARCHITECTURE INC, THE COPYRIGHT IN THE SAME BEING RESERVED TO THEM. NO REPRODUCTION IS ALLOWED WITHOUT THE PERMISSION OF KEDDIE ARCHITECTURE INC AND WHEN MADE MUST BEAR ITS NAME. THIS DRAWING IS NOT TO BE SCALED. THE CONTRACTOR IS TO VERIFY DIMENSIONS AND DATA NOTED HEREIN WITH THE CONDITIONS ON SITE AND IS RESPONSIBLE FOR REPORTING

### VISIONS ELECTRONICS EMERALD HILLS CENTRE

390 - 5000 EMERALD DRIVE STATHCONA COUNTY, AB

DRAWING TITLE

#### REFLECTED CEILING PLAN

DRAWING ISSUED


DRAWING NO.

**BUILDING PERMIT** 

PROJECT NO. 2012-05-09 1201 SCALE AS NOTED

REVISION

A-2.0

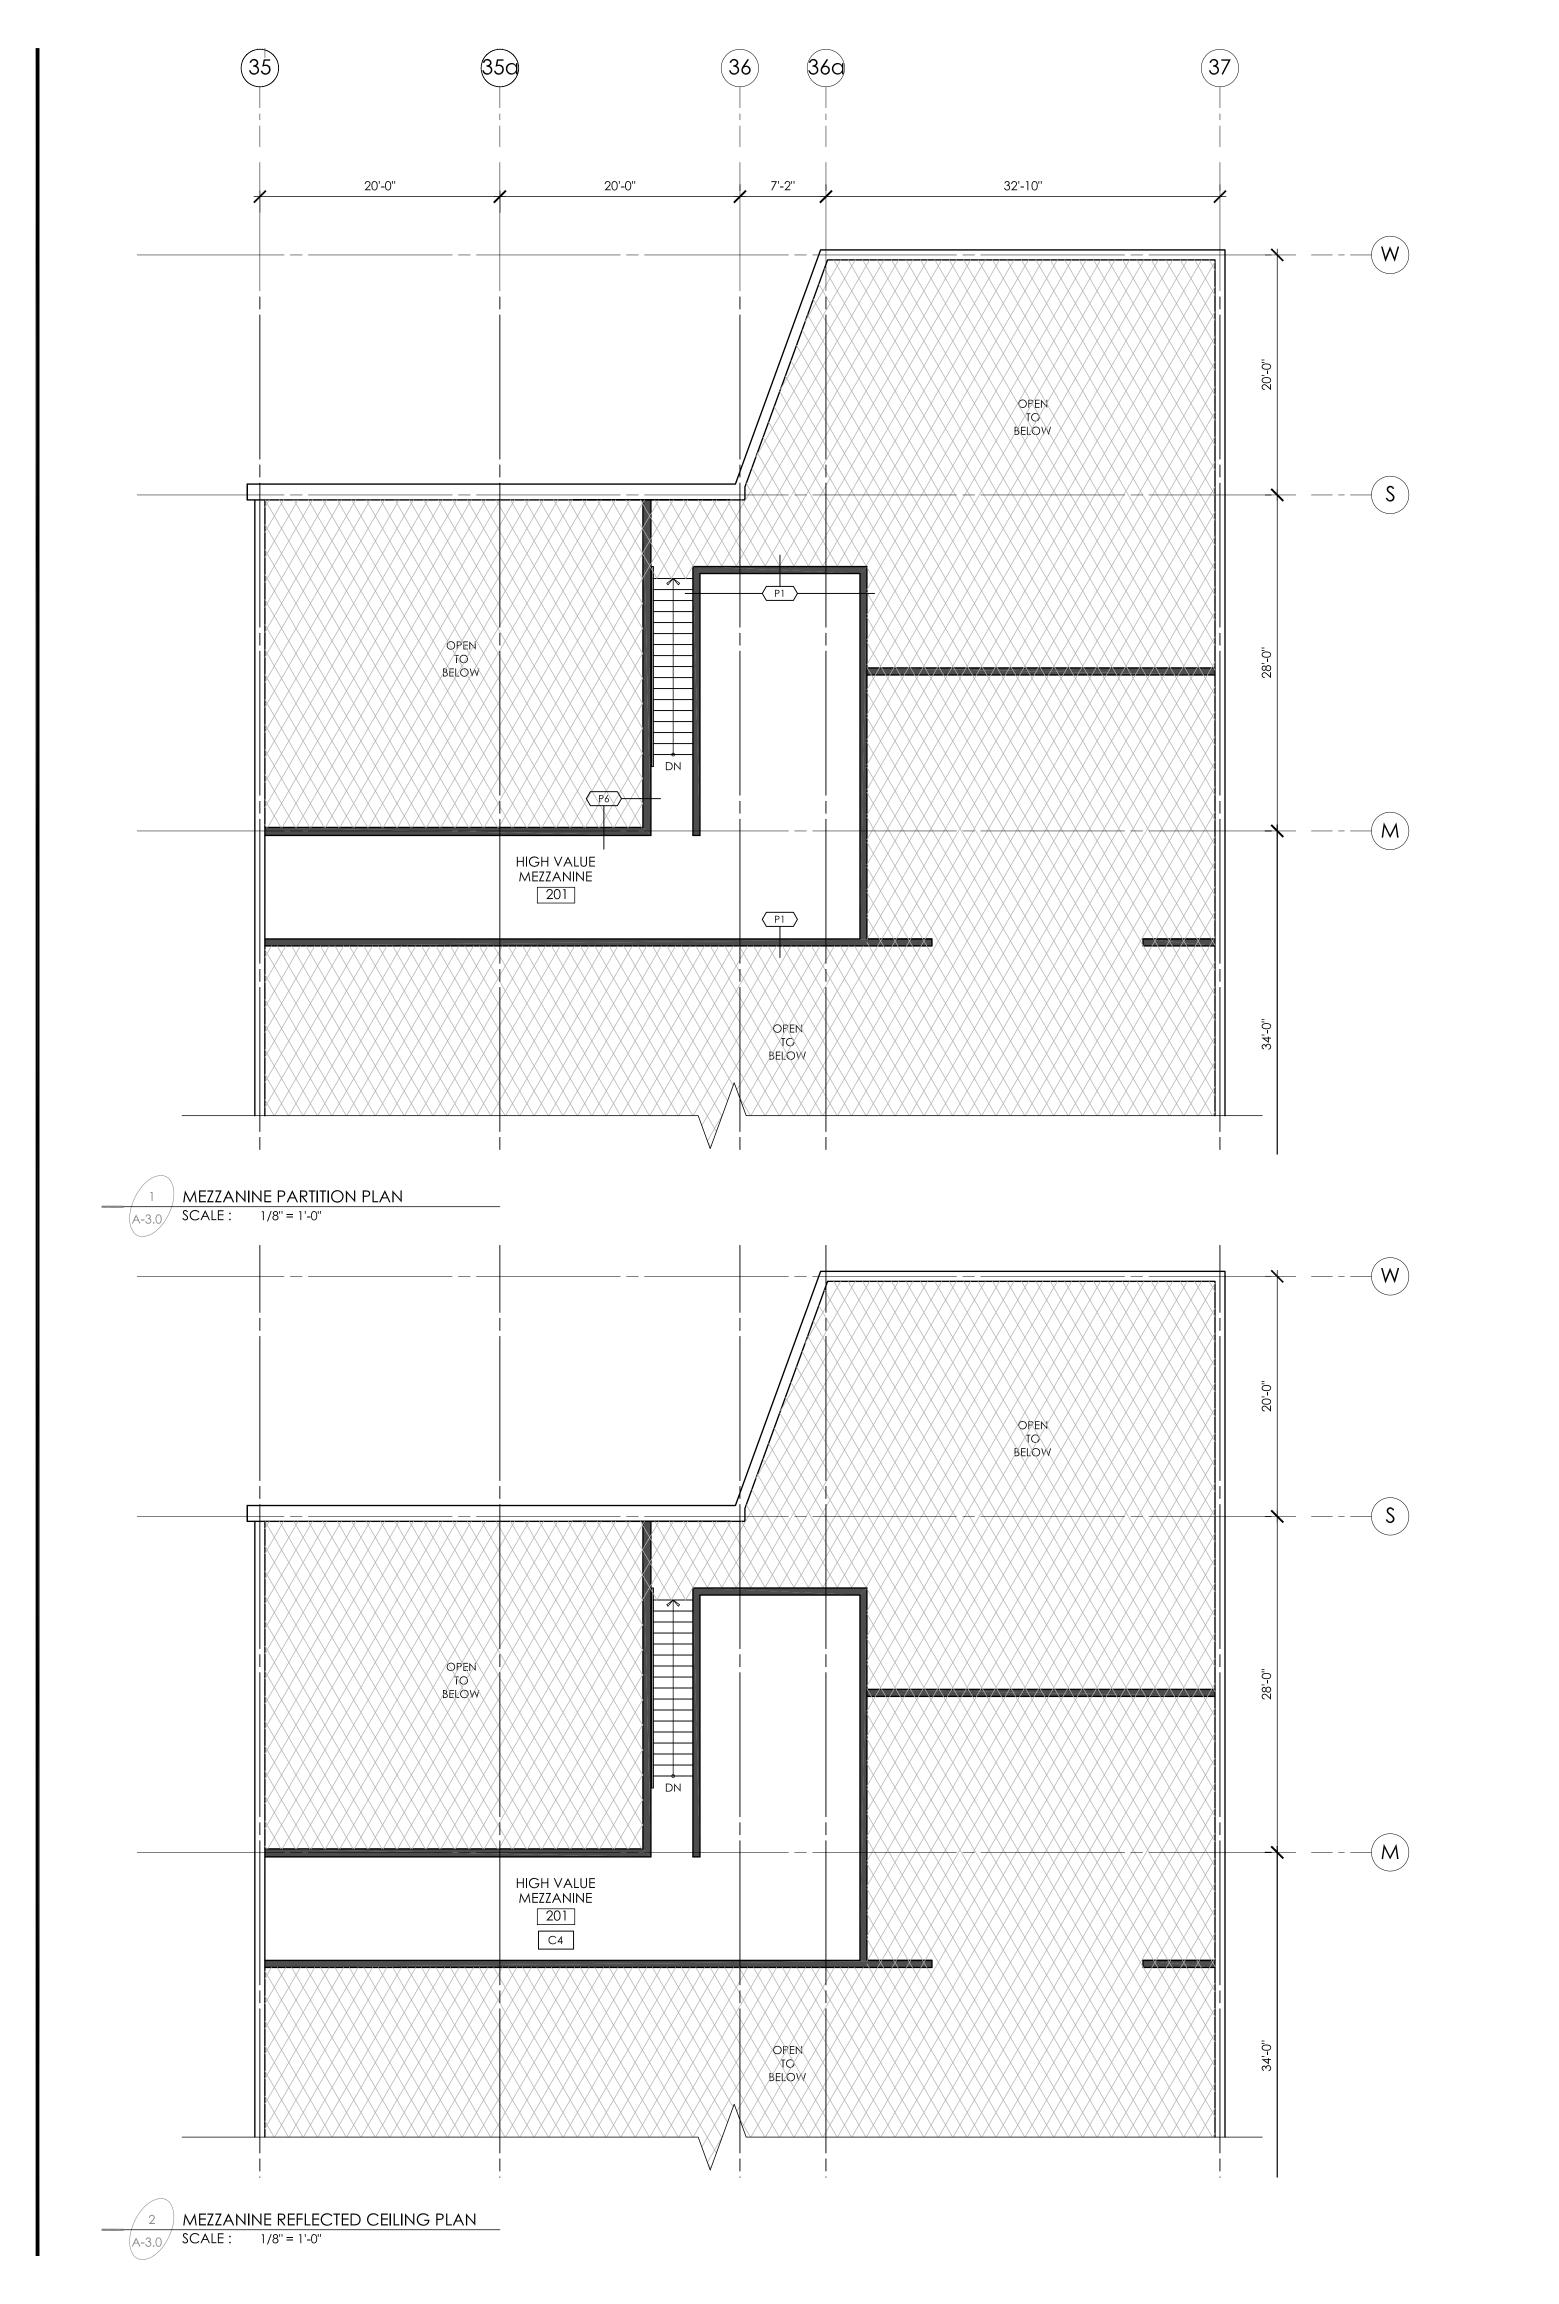

PARTITION TYPES LEGEND P1 NEW GYPSUM BOARD PARTITION TYPE P1 → 1/2" GYPSUM BOARD DECK OR MEZZANINE FLOOR 1/2" GYPSUM BOARD P2 NEW GYPSUM BOARD PARTITION TYPE P2

• 1/2" GYPSUM BOARD DECK OR MEZZANINE FLOOR BATT INSULATION 1/2" GYPSUM BOARD P3 NEW GYPSUM BOARD PARTITION TYPE P3

• 1/2" GYPSUM BOARD DRYWALL CEILING 1/2" GYPSUM BOARD P4 NEW GYPSUM BOARD PARTITION TYPE P4

1/2" GYPSUM BOARD DRYWALL CEILING BATT INSULATION 1/2" GYPSUM BOARD P5 NEW GYPSUM BOARD PARTITION TYPE P5

1/2" GYPSUM BOARD 1/2" GYPSUM BOARD P6 NEW 1.5 HR F/R PARTITION TYPE P6: ULC Des U423

• 2 LAYERS - 1/2" TYPE X GYPSUM BOARD 2 LAYERS - 1/2" TYPE X GYPSUM BOARD

**GENERAL NOTES:** . THESE DRAWINGS ARE TO BE READ IN CONJUNCTION WITH ALL CONSULTANT DRAWINGS 6" 20ga STEEL STUDS @16" O.C. TO U/S OF ROOF AND SPECIFICATIONS. 2. THE CONTRACTOR SHALL REVIEW THE EXISTING PREMISES CAREFULLY PRIOR TO COMMENCING CONSTRUCTION; ANY SITE CONDITION OR DIMENSIONS FOUND TO BE DIFFERENT THAN THOSE SHOWN ON THE DRAWINGS, SHALL BE REPORTED TO THE ARCHITECT IMMEDIATELY PRIOR TO • 6" 20ga STEEL STUDS @16" O.C. TO U/S ROOF PROCEEDING WITH WORK. 3. ALL WORK TO COMPLY WITH THE MOST CURRENT EDITION OF THE BRITISH COLUMBIA BUILDING CODE (2006 BCBC) AND REFERENCED DOCUMENTS. 4. CONSTRUCTION STANDARDS FOR MATERIAL AND WORKMANSHIP QUALITY MUST COMPLY WITH • 3 5/8" 20ga STEEL STUDS @16" O.C. TO U/S OF PREVAILING COMMONLY RECOGNIZED ROOF DECK, MEZZANINE FLOOR, T-BAR OR CONSTRUCTION INDUSTRY STANDARDS. 5. ALL MATERIAL, EQUIPMENT, FIXTURES AND FITTINGS TO BE NEW UNLESS OTHERWISE NOTED, AND INSTALLED ACCORDING TO MANUFACTURERS' RECOMMENDATIONS. 3 5/8" 20ga STEEL STUDS @16" O.C. TO U/S OF 6. CONFIRM ALL SIZES OF TENANT'S EQUIPMENT AND ROOF DECK, MEZZANINE FLOOR, T-BAR OR appliances. 7. ALL PENETRATIONS THOUGH FIREWALLS, ARE TO BE PACKED WITH MINERAL FIBRE INSULATION AND CAULKED TO MAINTAIN INTEGRITY OF THE SEPARATION. ALL CONTRACTORS ARE RESPONSIBLE FOR THEIR OWN FIRESTOPPING UNLESS NOTED 3 5/8" 20ga STEEL STUDS @16" O.C. TO 48" HIGH OTHERWISE. 8. ALL PARTITIONS THAT CONTINUE TO THE U/S OF STRUCTURE ARE TO HAVE DEFLECTION TRACKS. 9. CONCRETE SLABS ARE PRESUMED TO BE IRREGULAR THE CONTRACTOR IS TO ANTICIPATE TOPPING, THOROUGHLY CLEAN EXISTING CONCRETE SLAB OF 6" 20ga STEEL STUDS @16" O.C. TO U/S OF ROOF ALL ADHESIVE AND DEBRIS. FLOAT TO LEVEL FLOOR DECK (DOUBLE TRACK @ TOP; GWB SEALED TO PRIOR TO INSTALLATION OF NEW FLOOR FINISHES U/S DECK W/ COMPRESSIBLE NON COMBUSTIBLE AND WALL CONSTRUCTION. LEVELING BED TO BE 1/4" HEIGHT MAXIMUM DIFFERENCE OVER RUN OF 10. PROVIDE SHALL MEAN SUPPLY AND INSTALL. 11. ALL EXISTING SURFACES TO REMAIN ARE TO BE PROTECTED DURING DEMOLITION & CONSTRUCTION AND SHOULD BE THOROUGHLY

REVIEW BY ARCHITECT.

APPROVAL.

FINISHES AND MATERIALS TO OWNER FOR

#### CONSTRUCTION LEGEND DENOTES AREA NOT IN CONTRACT DENOTES OPEN TO BELOW EXISTING PARTITION TO REMAIN **NEW PARTITION** DENOTES NEW MILLWORK. SUPPLY ADEQUATE BACKING FOR SUPPORT AS REQUIRED. CONSTRUCTION GENERAL NOTES 1. CONSTRUCT PARTITIONS RIGHT TO THE FLOOR. ALL PARTITIONS ARE TO BE TAPED, FILLED AND SANDED SMOOTH TO RECEIVE NEW FINISHES. 2. RVOE CLIPS, CADDY CLIPS OR EQUAL MUST BE USED TO ADHERE ALL NEW PARTITIONS TO T-BAR CEILING GRID. UNDER NO CIRCUMSTANCES SHALL PARTITIONS BE SCREWED INTO T-BAR. ONLY "RAWL" NAILING ANCHORS OR LOW VELOCITY "HILTI" WITH MAXIMUM PENETRATION OF 19MM ARE TO BE USED TO ANCHOR PARTITIONS TO CONSULTANT FLOOR. SUPPLY, INSTALL AND TAPE ALL GYPSUM BOARD IN ACCORDANCE WITH A.W.C.C. "SPECIFICATION STANDARDS MANUAL" TAPE, FILL, SAND, SMOOTH AND LEVEL ALL JOINTS, EDGES, CORNERS ETC. PROVIDE METAL CORNER BEADS AND "J" MOLDS AT ALL CORNERS AND ENDS OR GYPSUM BOARD RESPECTIVELY. 4. FURR GYPSUM BOARD TIGHT TO ALL STRUCTURAL COLUMNS WHERE SERVICES ARE NOT REQUIRED. 5. NEW SWING DOORS SHALL BE LOCATED 100mm (4") FROM ADJACENT PARTITIONS UNLESS NOTED OTHERWISE. 6. NO THERMOSTATS AND/OR LIGHT SWITCHES ARE TO BE LOCATED ON RETAIL / DISPLAY WALLS. 7. PROVIDE ADEQUATE SOLID WOOD BLOCKING IN WALLS WHERE WALL MOUNTED ACCESSORIES (INCLUDING GRAB BARS) ARE REQUIRED PRIOR TO CLEANED WHEN CONSTRUCTION COMPLETE. BOARDING. INSTALL LEVEL AND PLUMB, RIGIDLY ANCHORED TO SUBSTRATE. 12. CONTRACTOR TO PROVIDE SHOP DRAWINGS FOR 8. INSTALL ALL FIXTURES AND ACCESSORIES IN ACCORDANCE WITH MANUFACTURERS' 13. CONTRACTOR TO PROVIDE SAMPLES OF ALL INSTRUCTIONS, AND IN ACCORDANCE WITH BARRIER FREE GUIDELINES, BASED ON THE LATEST BRITISH COLUMBIA BUILDING CODE (2006 BCBC). 9. REFER TO MILLWORK ELEVATIONS FOR MILLWORK DIMENSIONS. 10. FURNITURE AND EQUIPMENT TO BE SUPPLIED BY OWNER U.N.O. CONSTRUCTION KEY NOTES $\langle 1 \rangle$ ALIGN NEW WALL TO EDGE OF COLUMN / STRUCTURAL ELEMENT OR EXISTING WALL PROVIDE ADEQUATE BLOCKING IN WALL FOR GRAB BARS AND ALL WC HARDWARE / **ACCESSORIES**


(3) ENSURE 300mm MIN. CLEARANCE AS REQUIRED

FRAMED DRYWALL OPENING FOR DATA CABINET; CONFIRM EXACT DIMENSIONS WITH

FRAME WALL TO ENCLOSE COLUMN c/w 1/2"
GWB EACH SIDE

(6) LINE OF MEZZANINE ABOVE

BY CODE

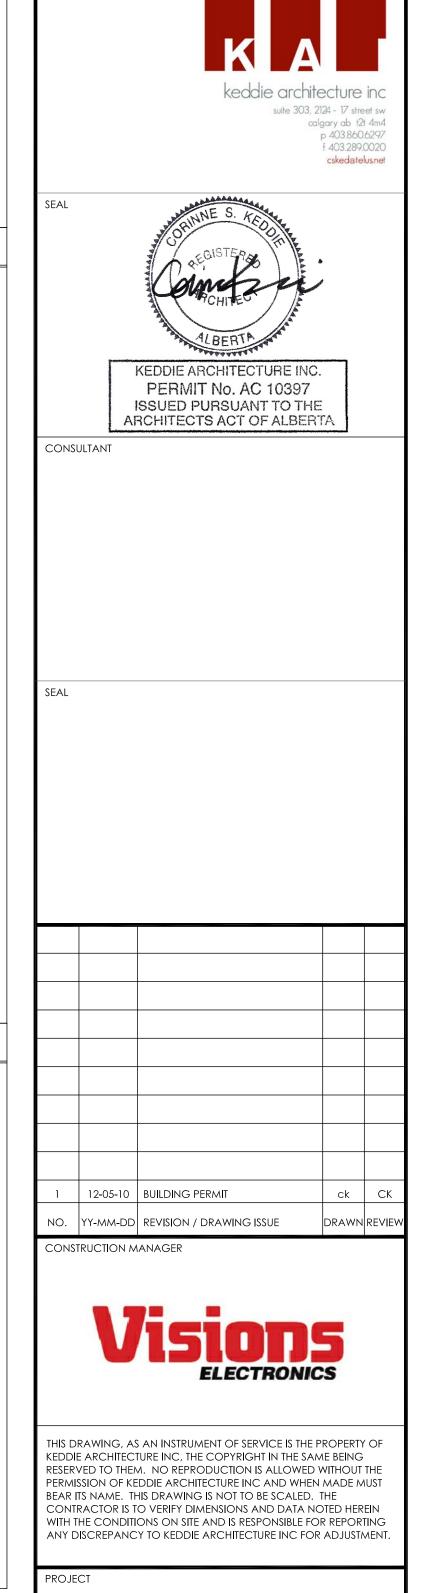

VISIONS ELECTRONICS EMERALD HILLS CENTRE

> 390 - 5000 EMERALD DRIVE STATHCONA COUNTY, AB

DRAWING TITLE

MEZZANINE PARTITION PLAN

REFLECTED CEILING PLAN

DRAWING ISSUED

**BUILDING PERMIT** 

PROJECT NO. 2012-05-09 1201 SCALE as noted DRAWING NO. REVISION

A - 3.0