3OJECT NO.:09.102FF

20670 LANGLEY BYPASS

LANGLEY BC



TURNER FLEISCHER

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PROJECT NO.:09.102FF

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LIST OF DRAWINGS

ARCHITECTURAL:

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M01 MECH FLOOR PLAN


M02 MECH SPECIFICATION, SCHEMATICS, LEGENDS & DETAILS

ELECTRICAL:

E01 ELECTRICAL SPECIFICATION, SCHEMATICS, LEGENDS & DETAILS E02 ELECTRICAL LAYOUT & DETAILS

BUILDING CODE INFORMATION:

BUILDING CLASSIFICATION: 3.2.2.60, GROUP E SPATIAL SEPARATION: 3.2.3.1D

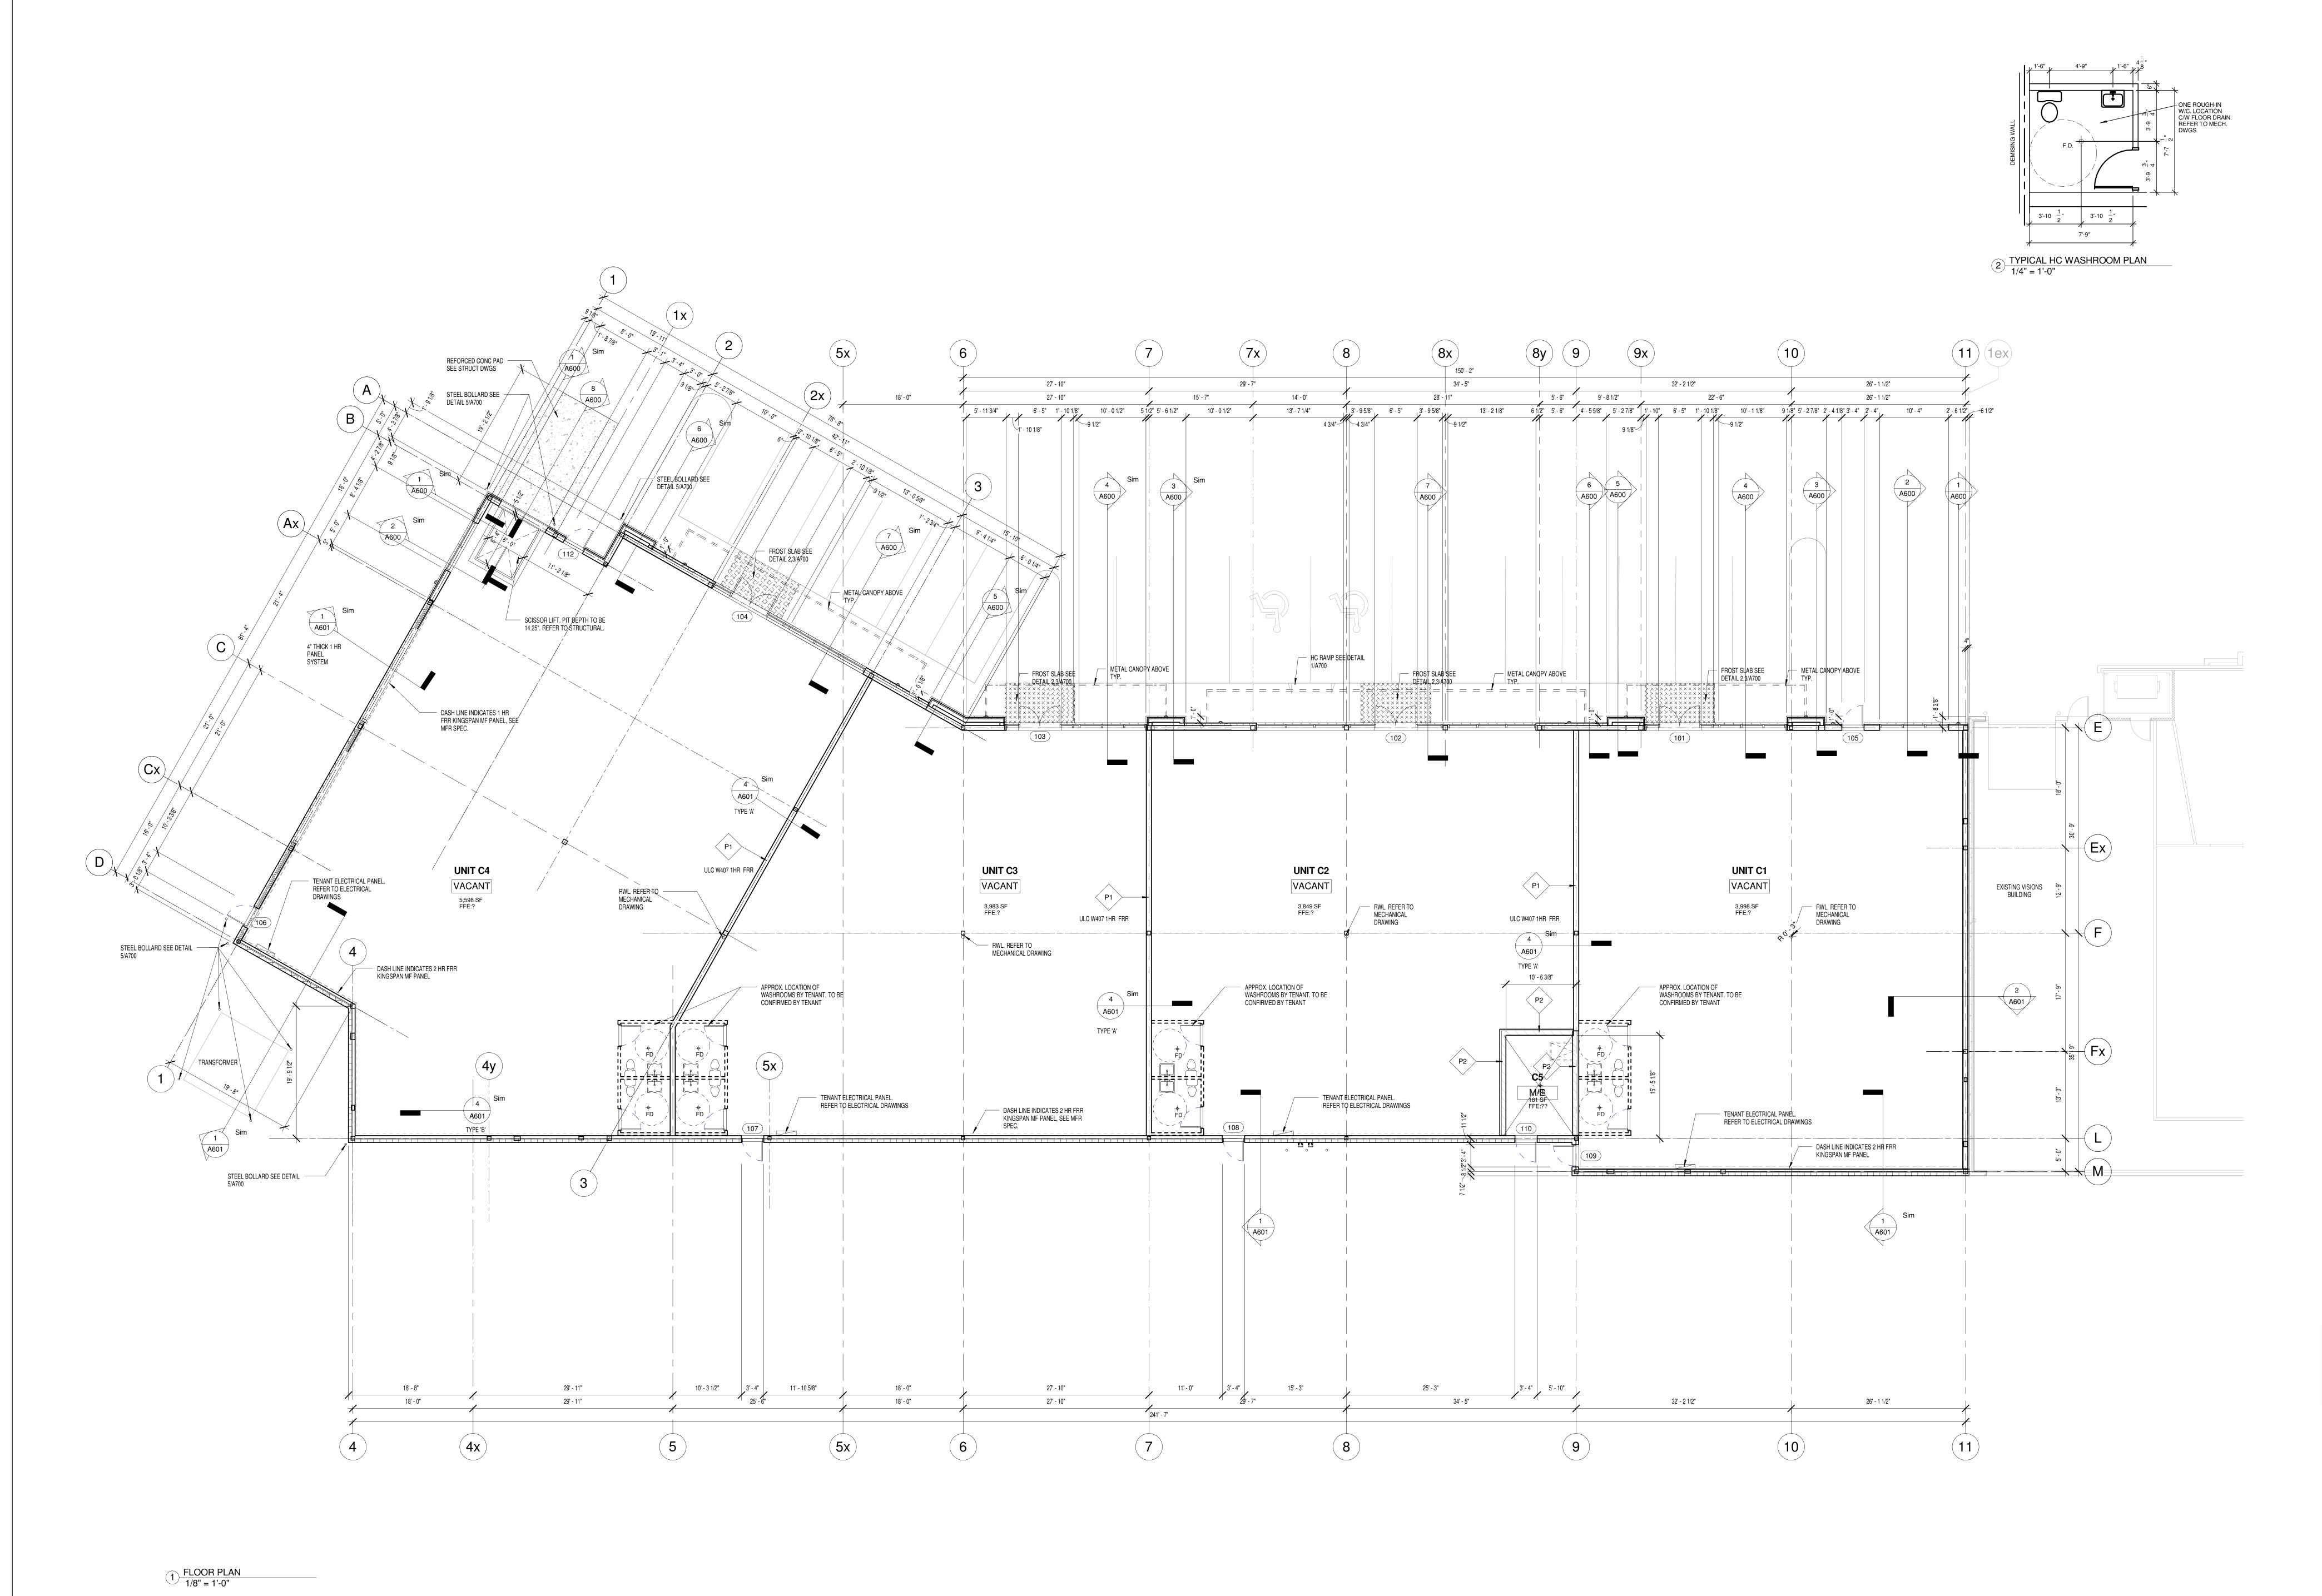

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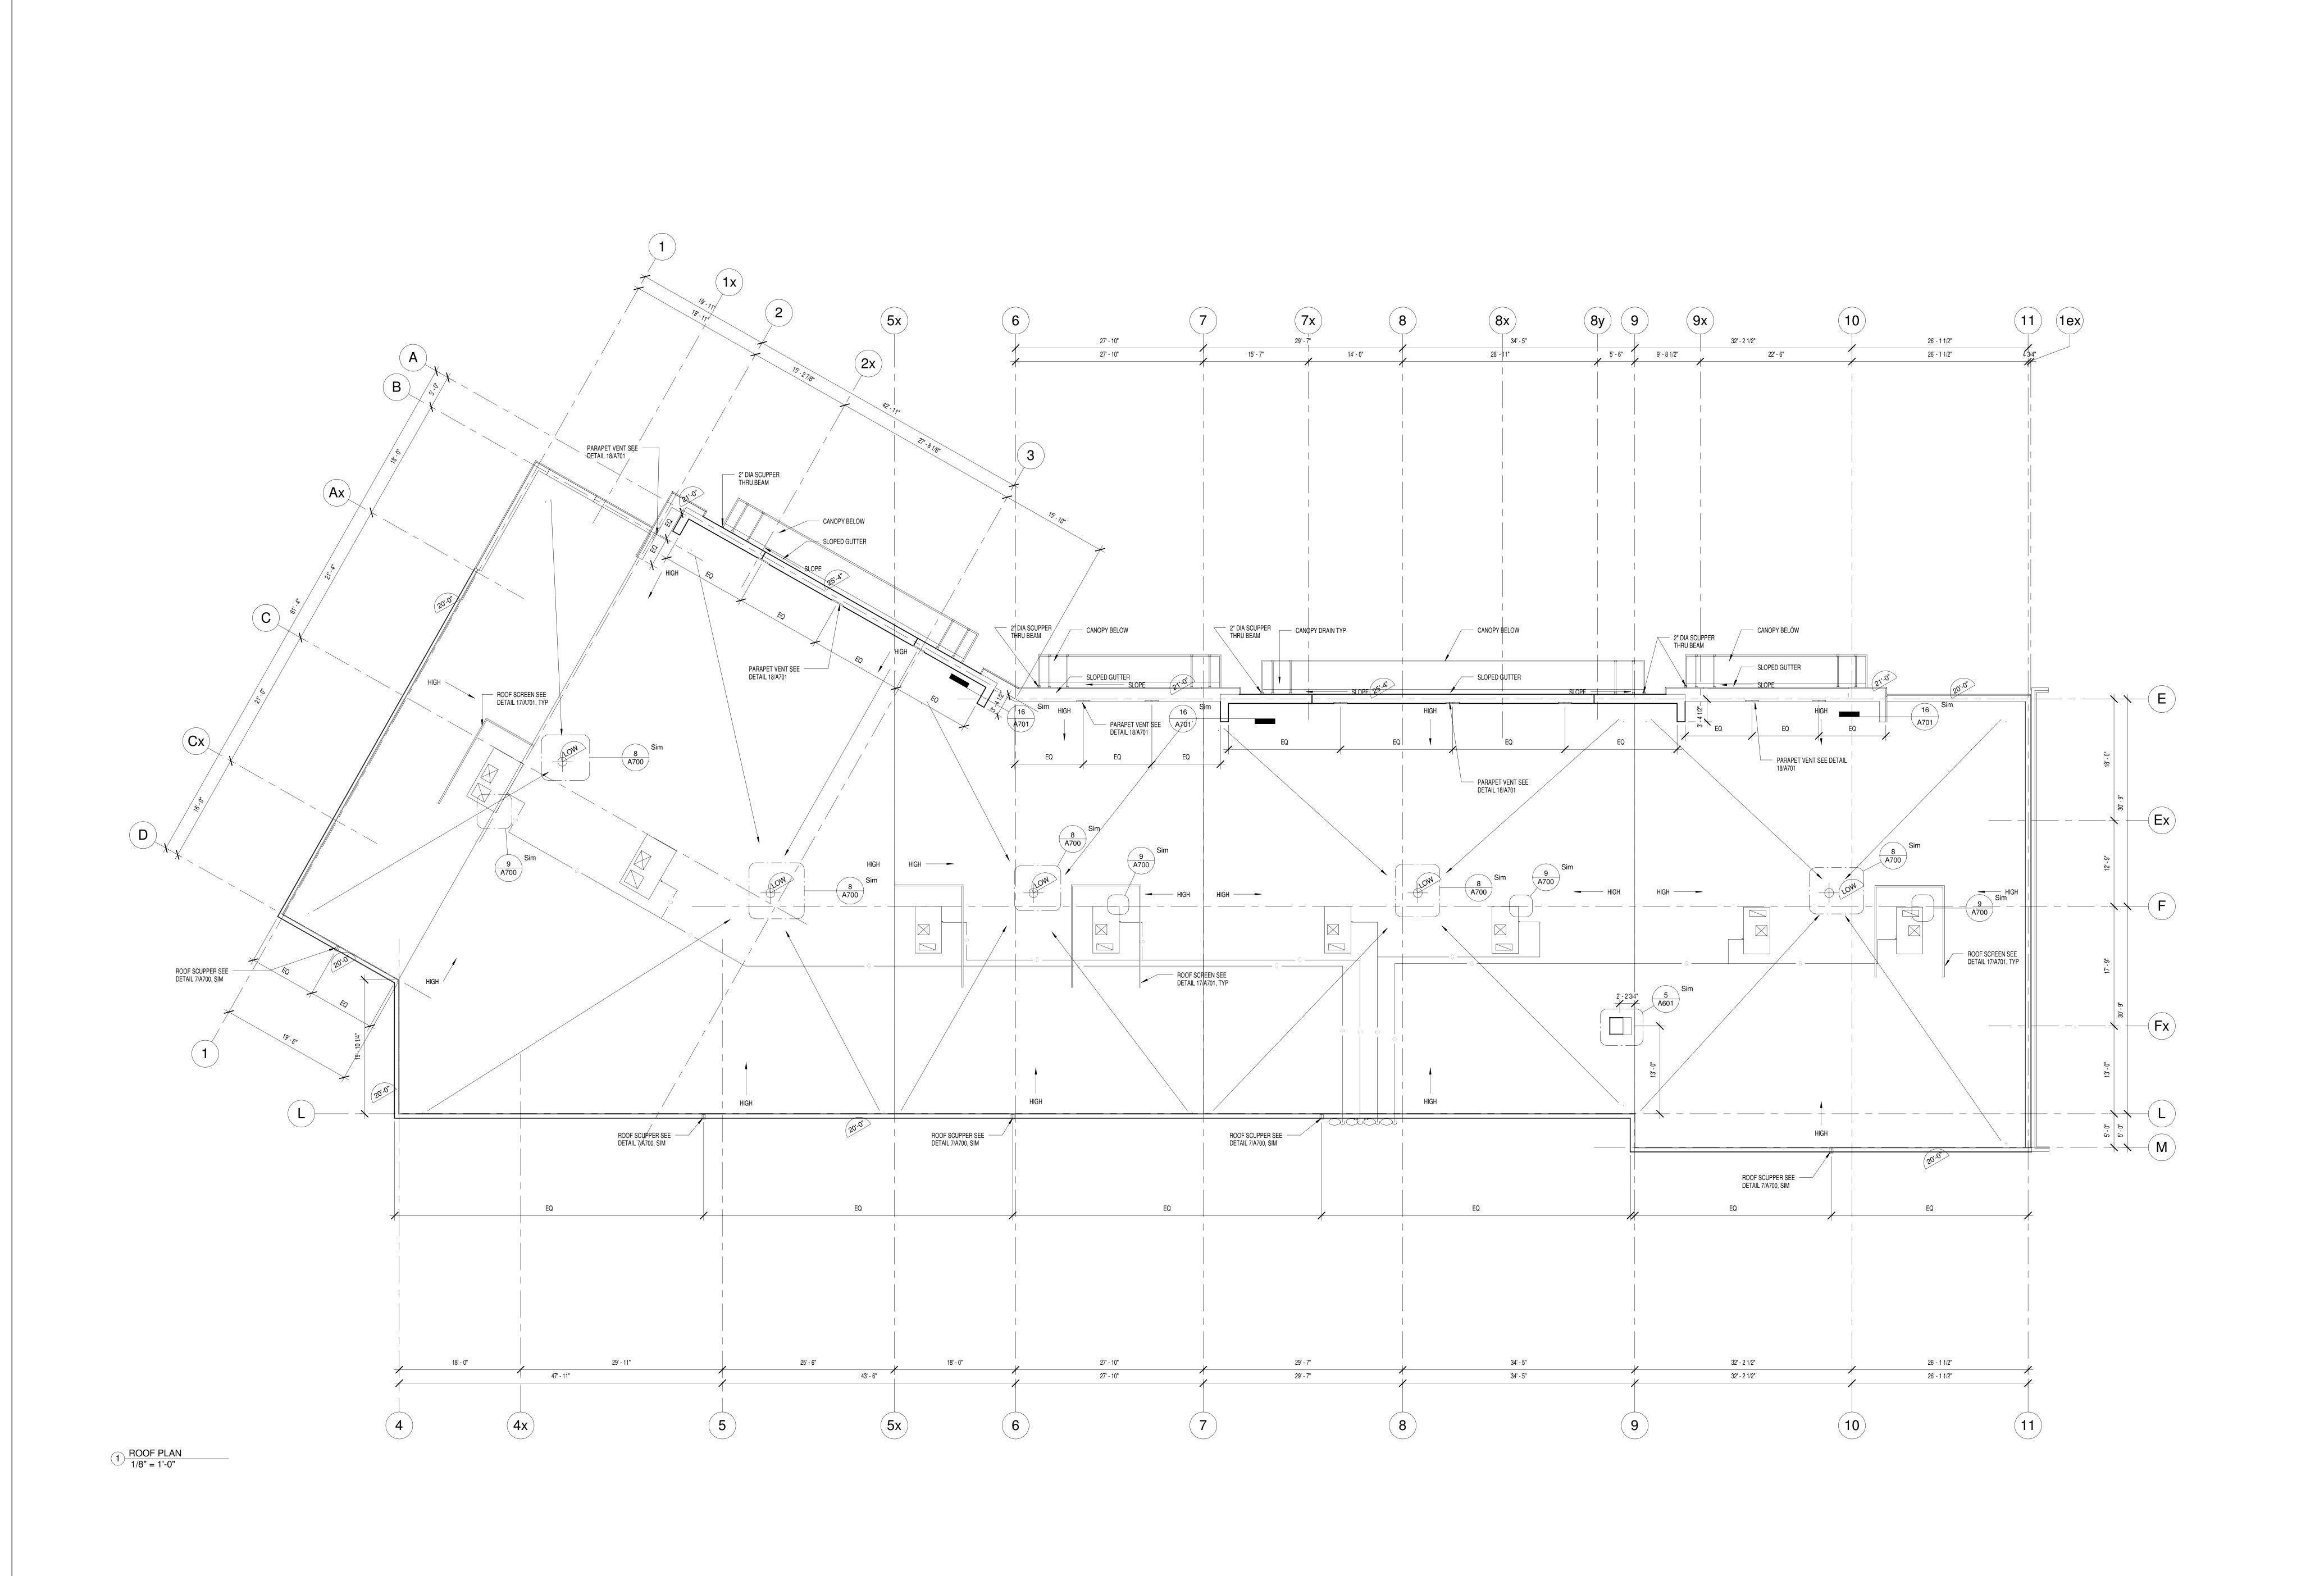
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FLOOR PLAN

rawn by: Author Scale:
Checked by: Checker Drawin

Drawing Name :

A200



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ROOF PLAN

Proj no.: 09.102FF Date:


Drawn by: ZL Scale:

Checked by: JM

Drawing No:

Drawing Name :

A201

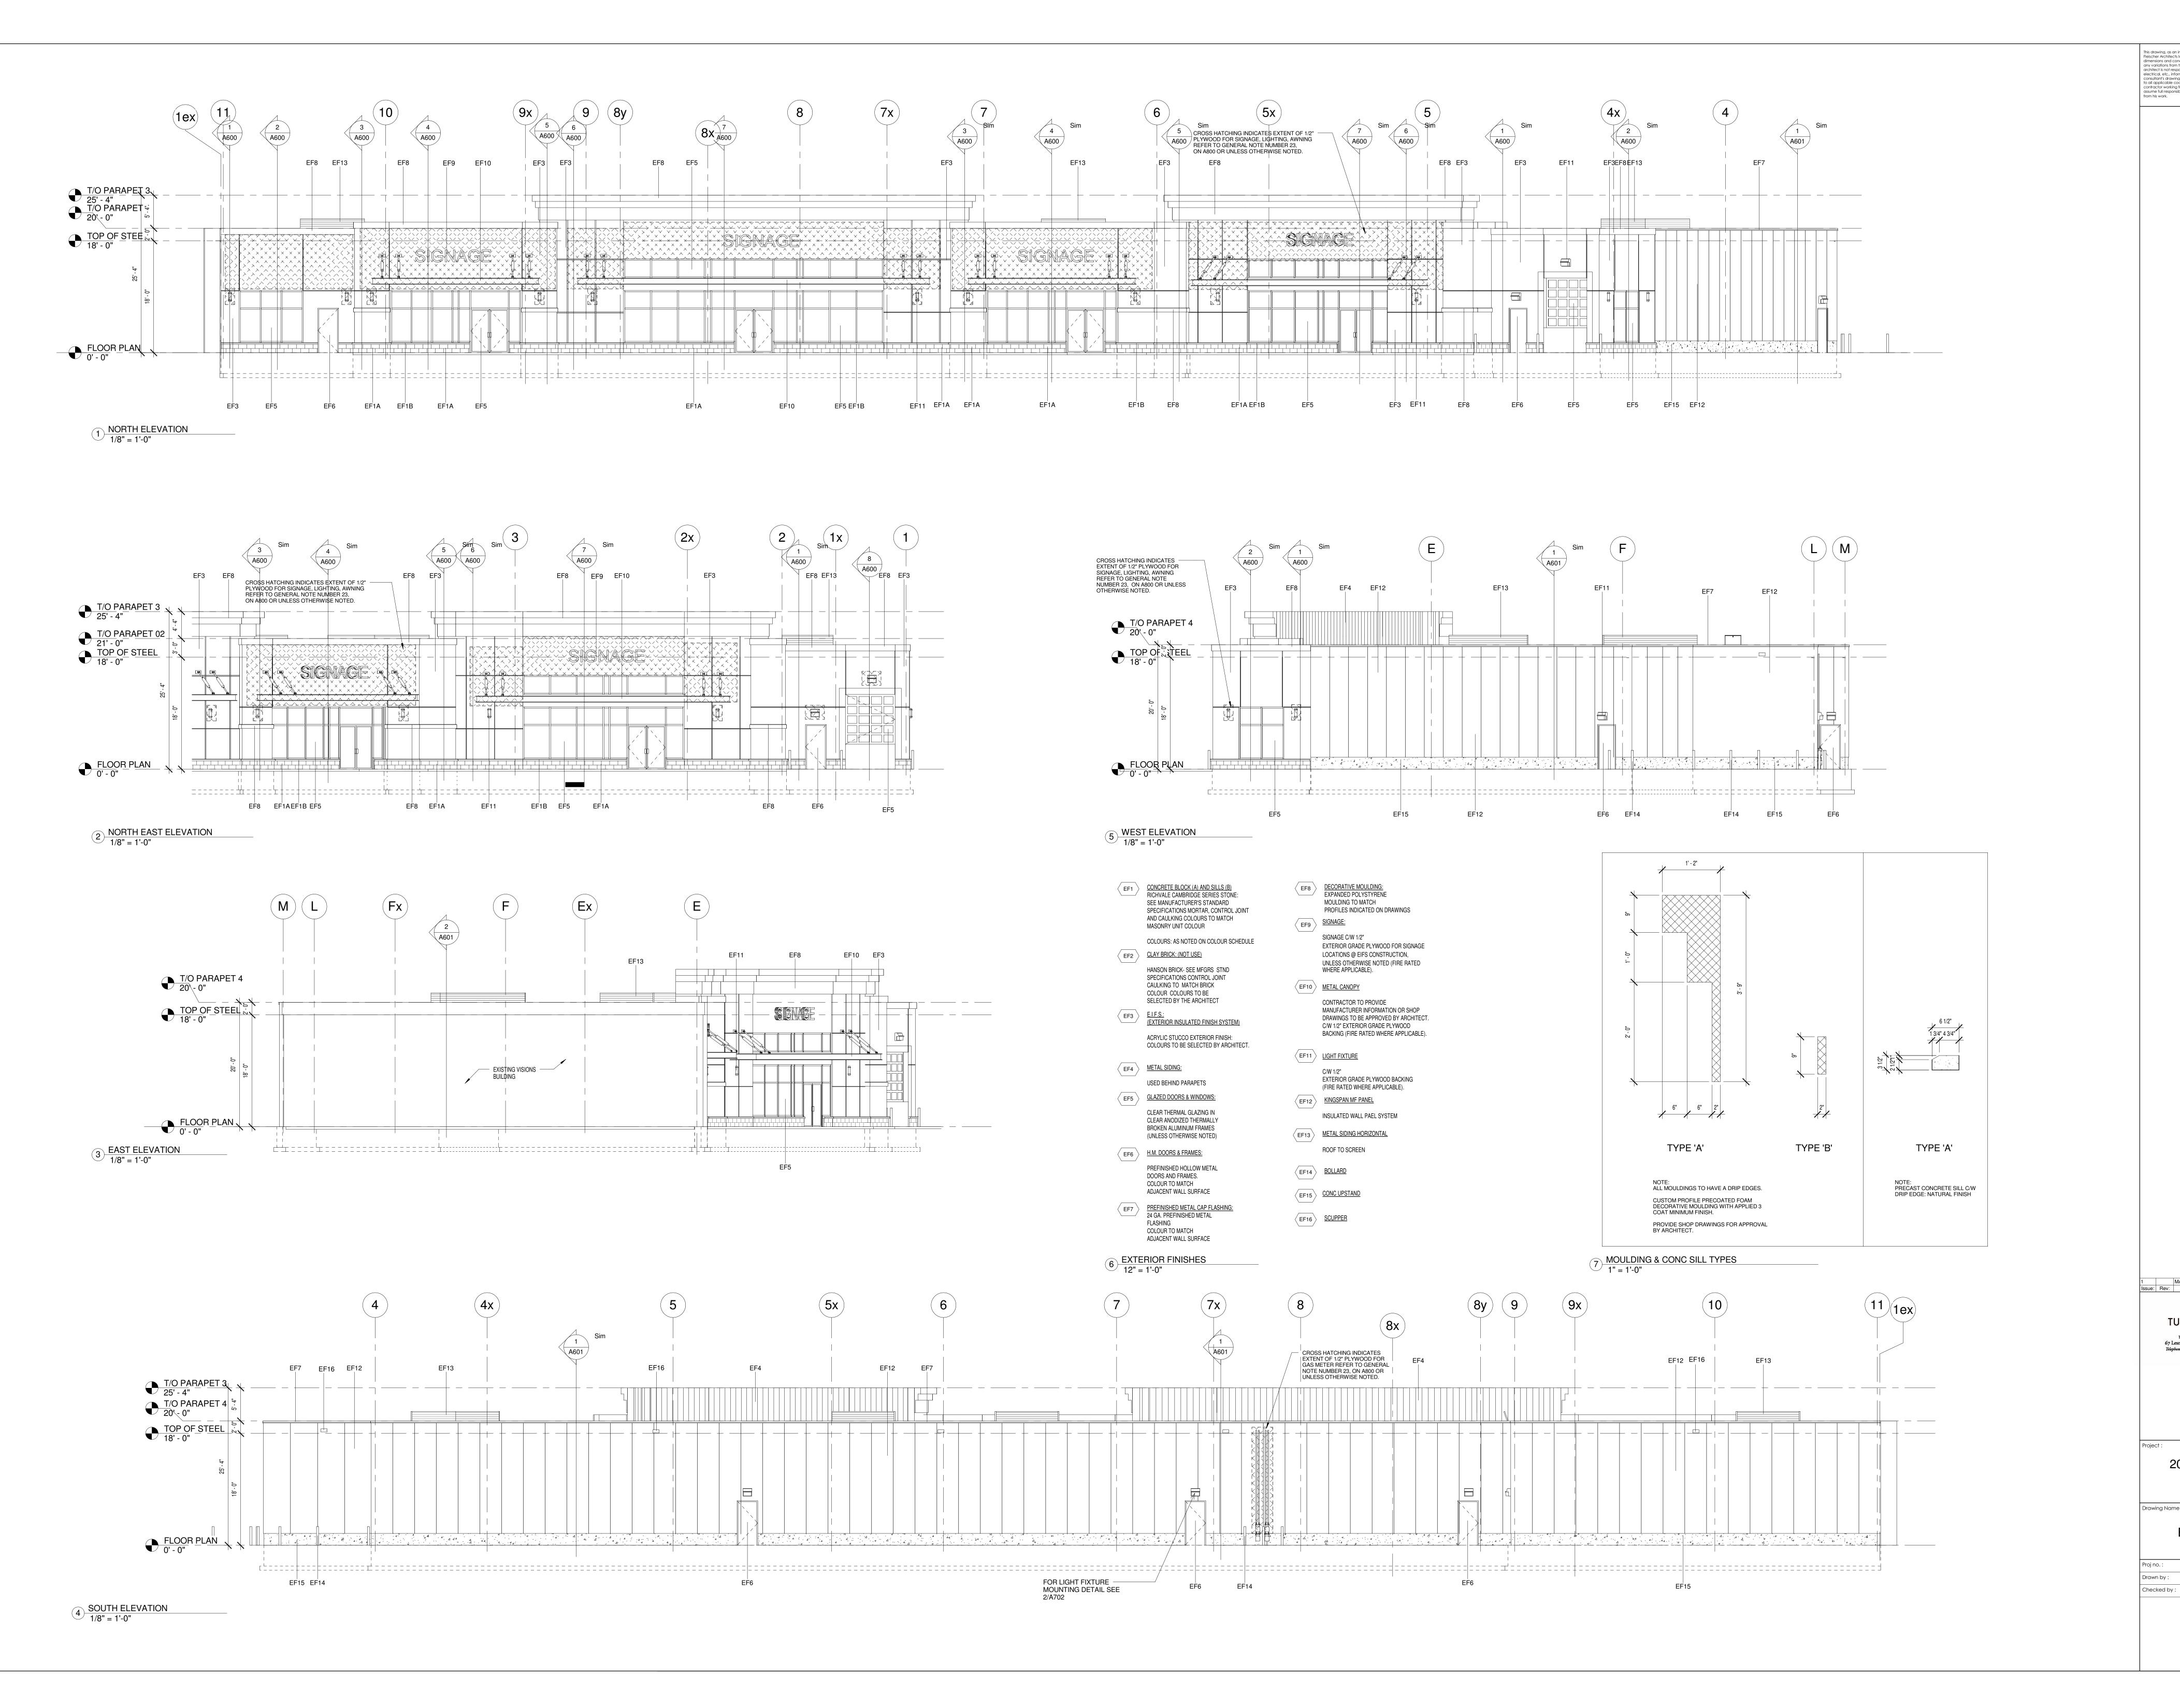

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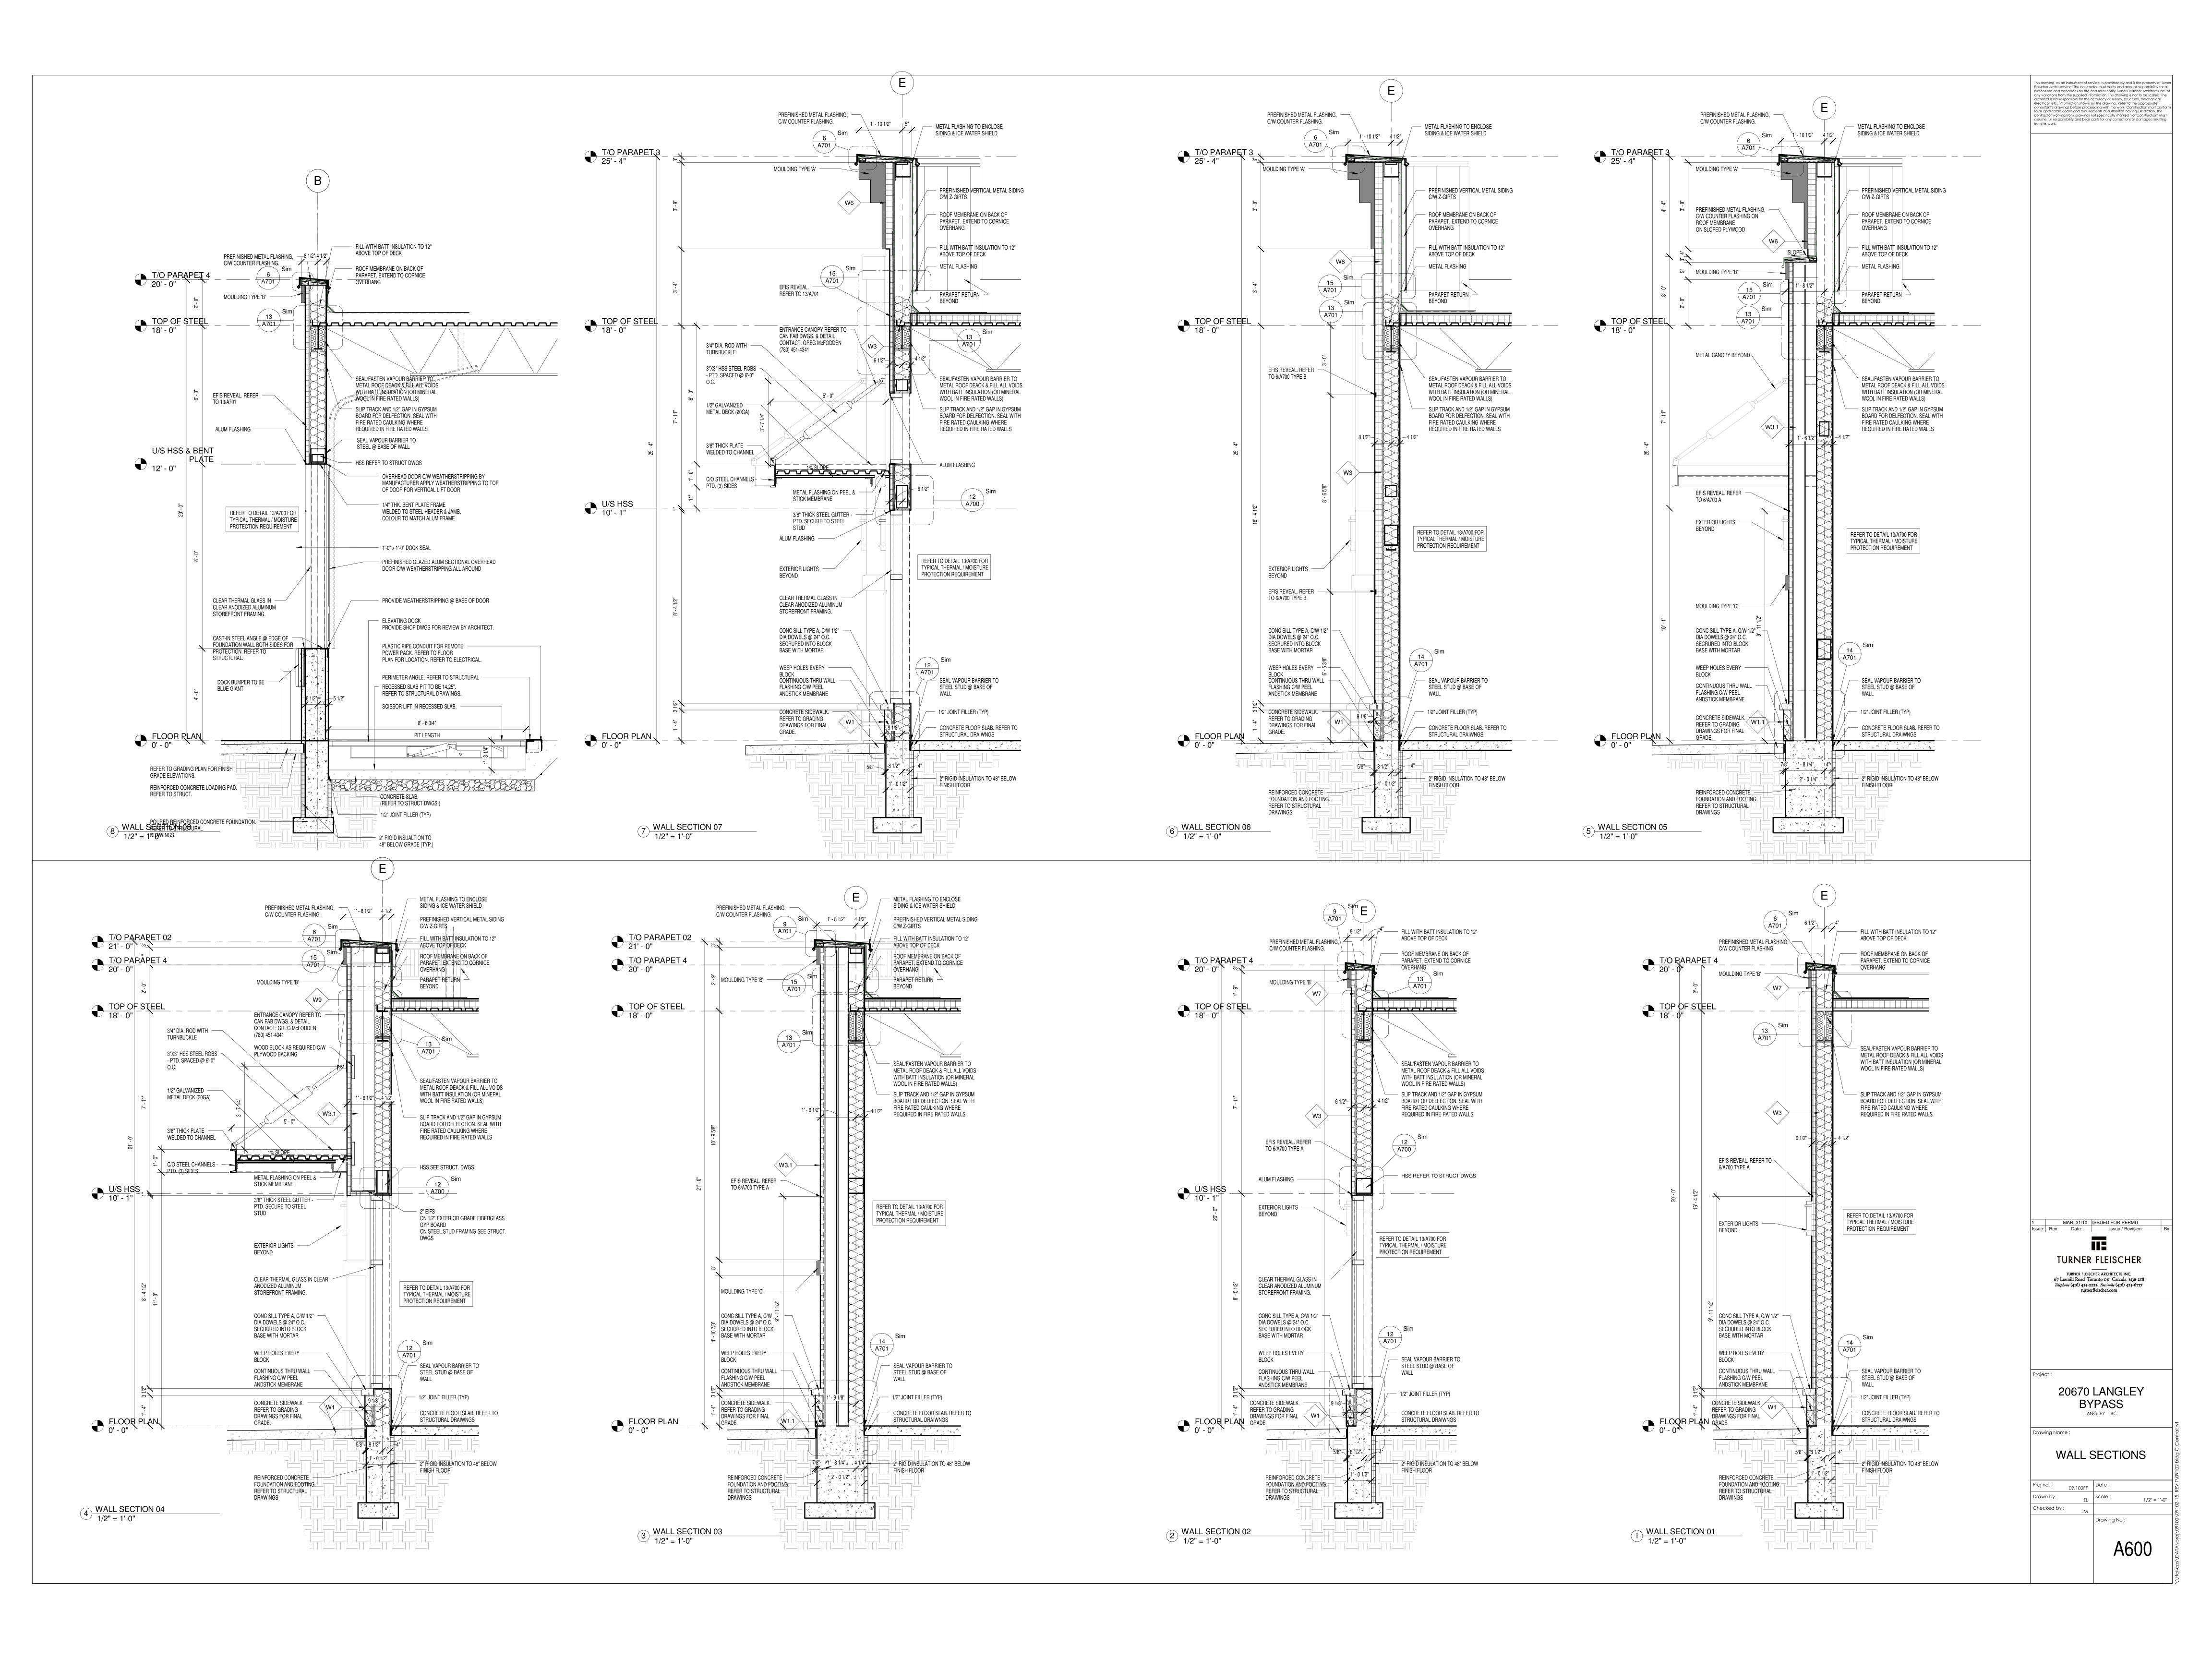
> 20670 LANGLEY BYPASS


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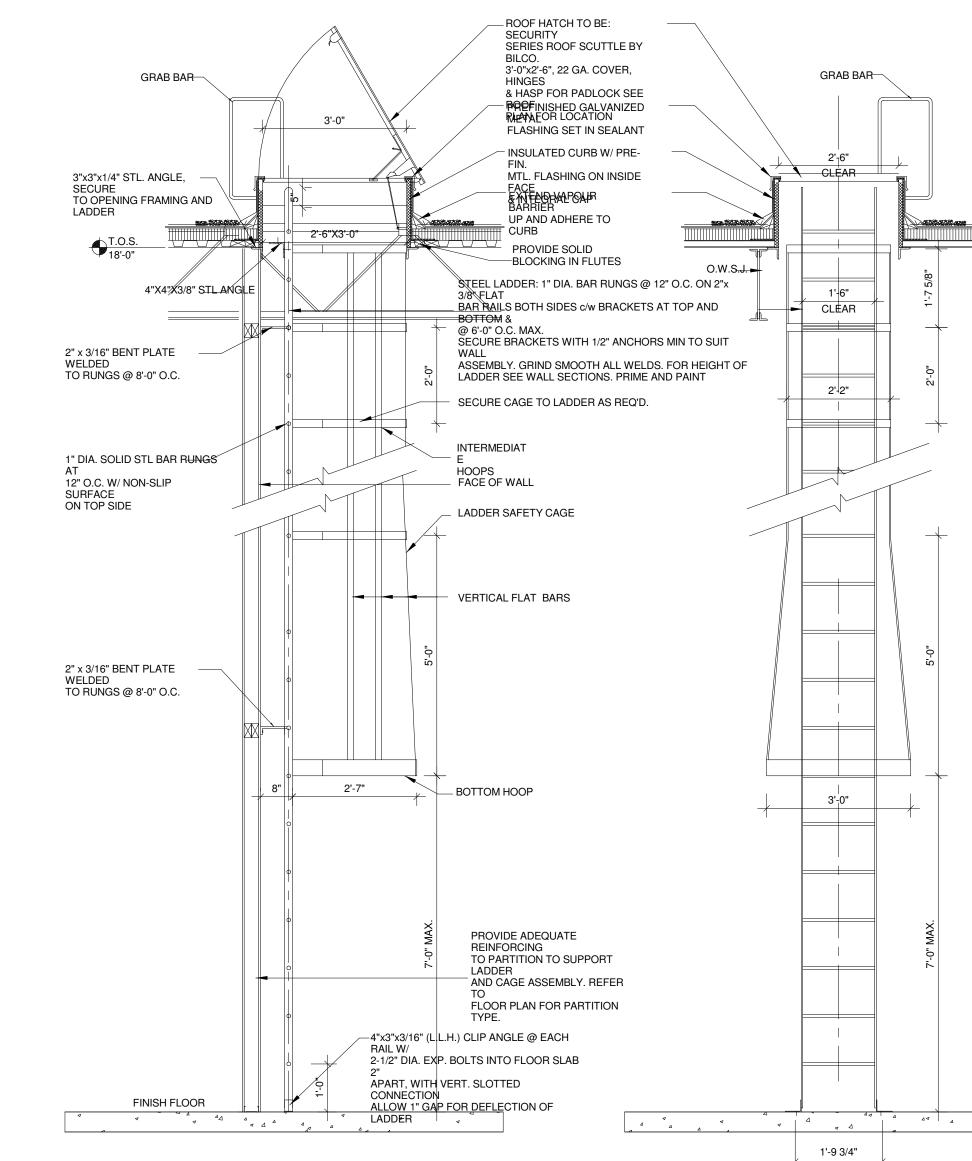
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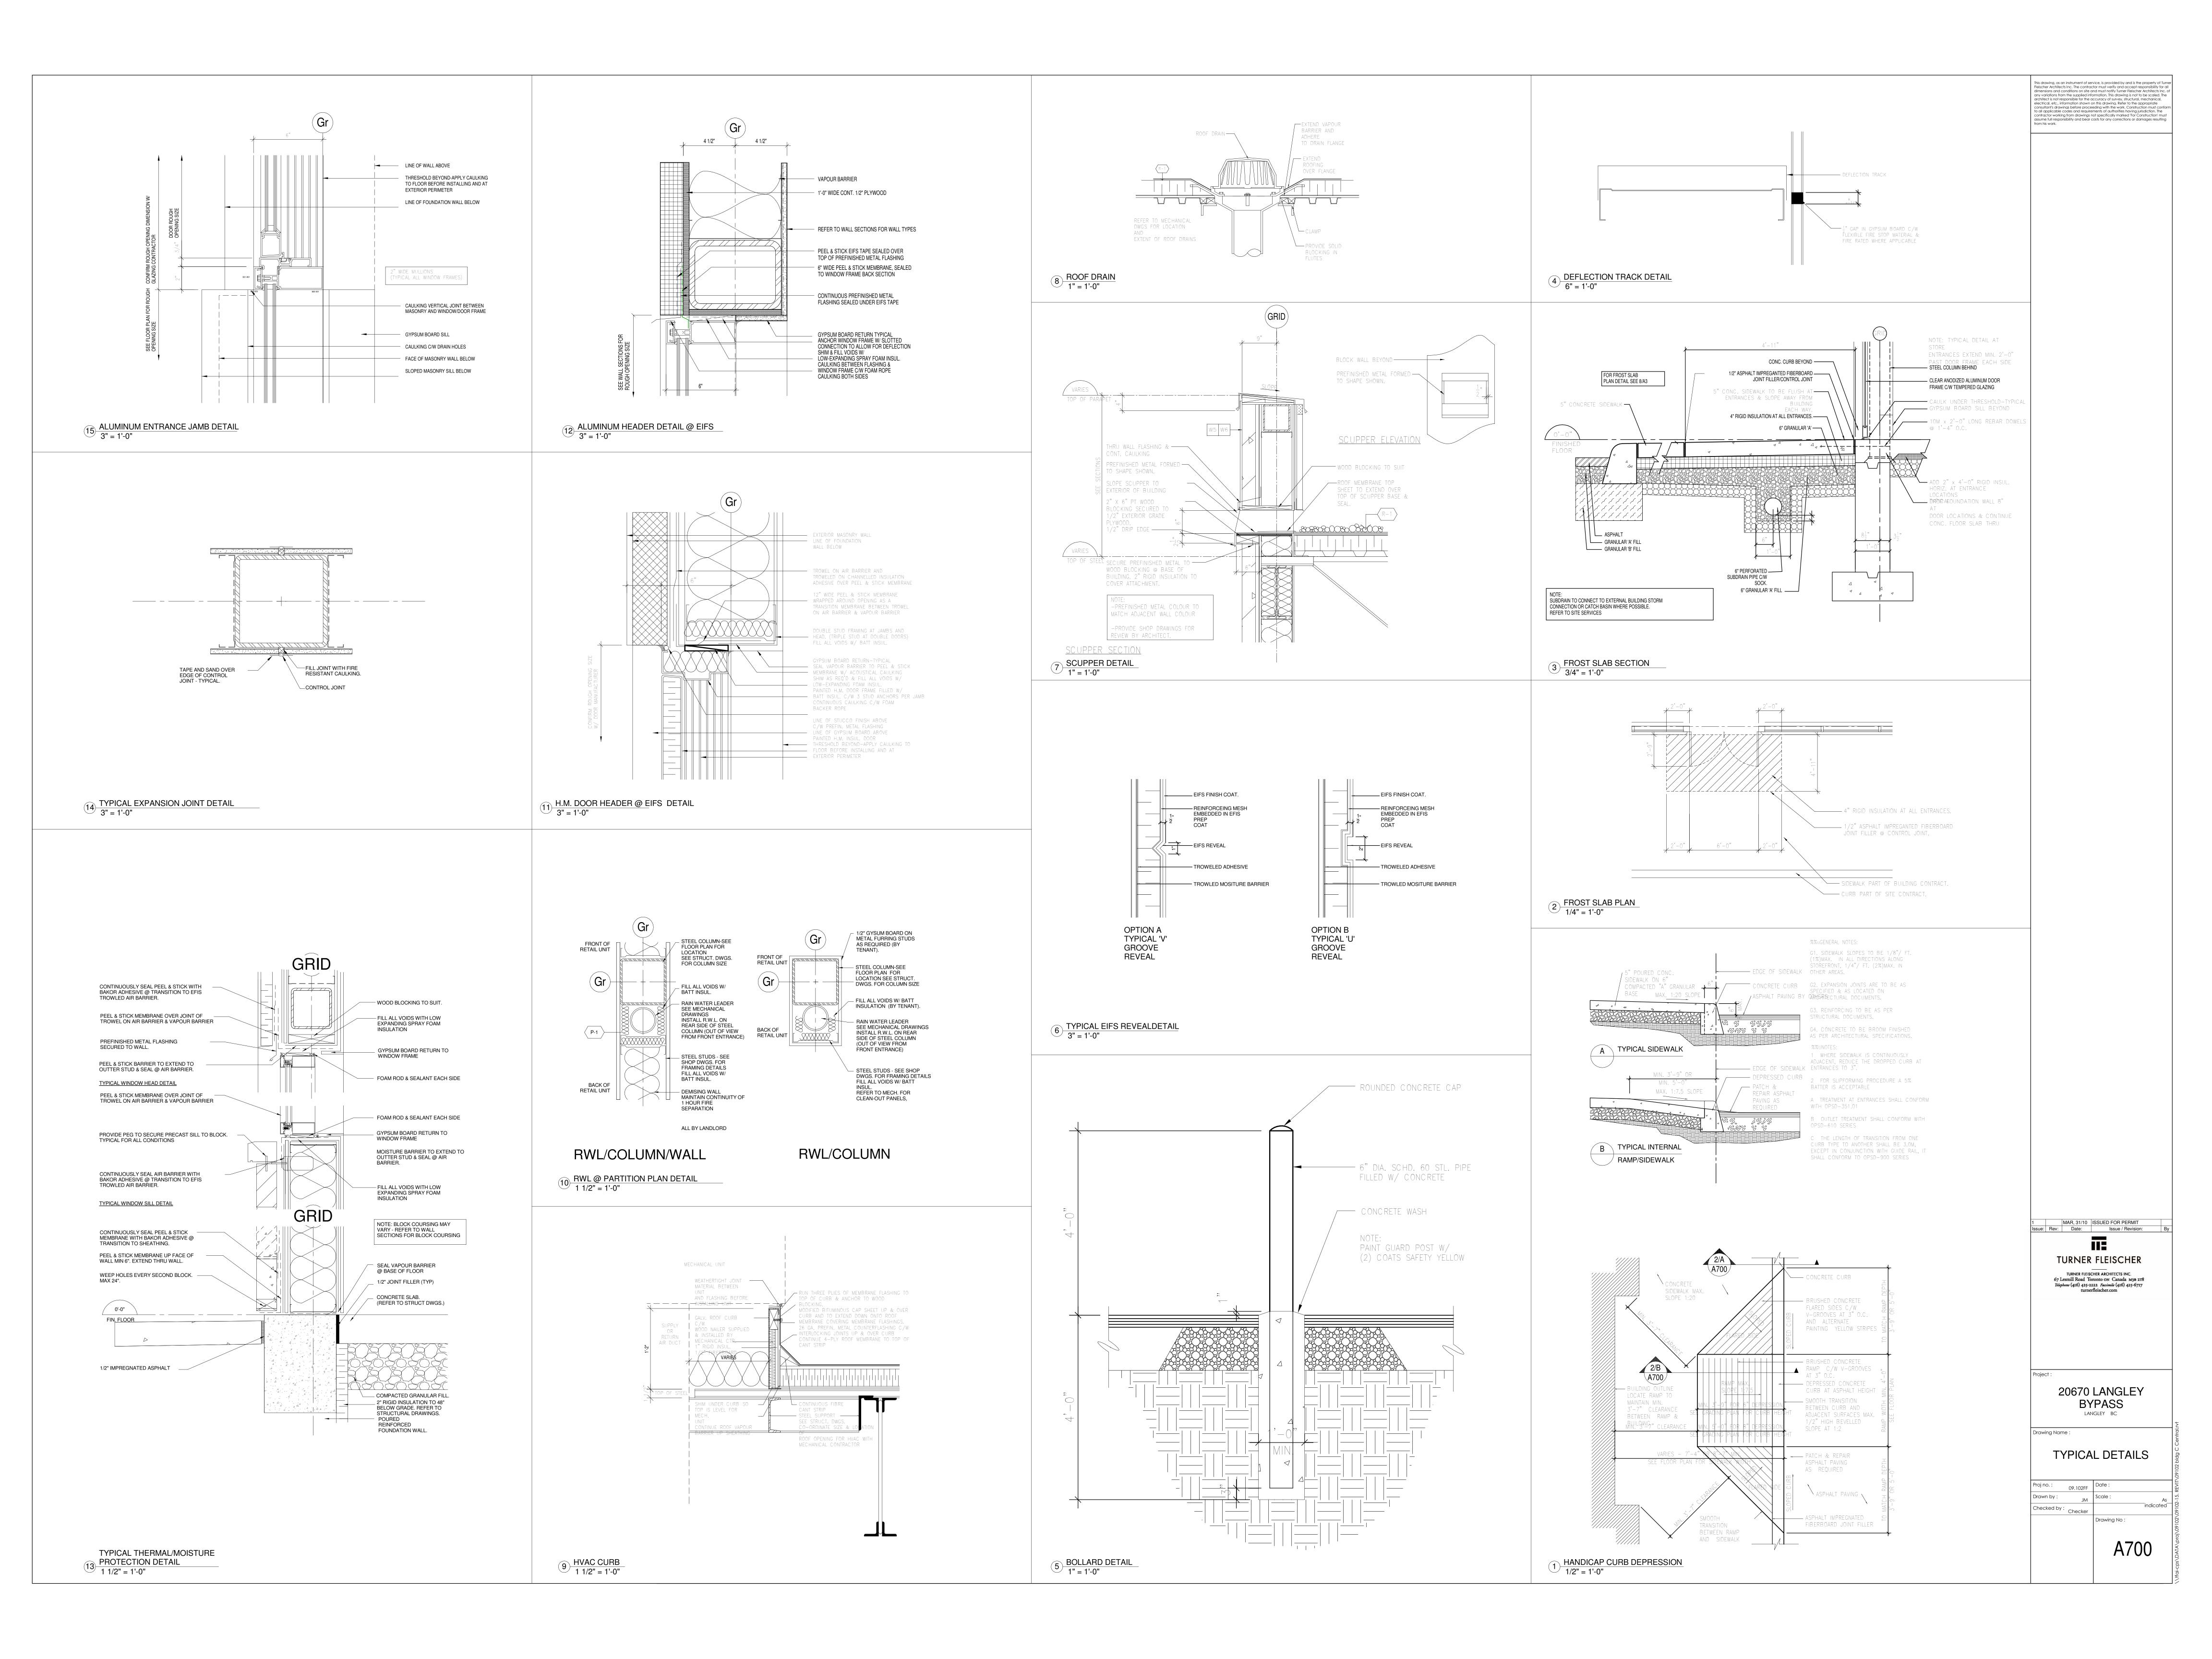
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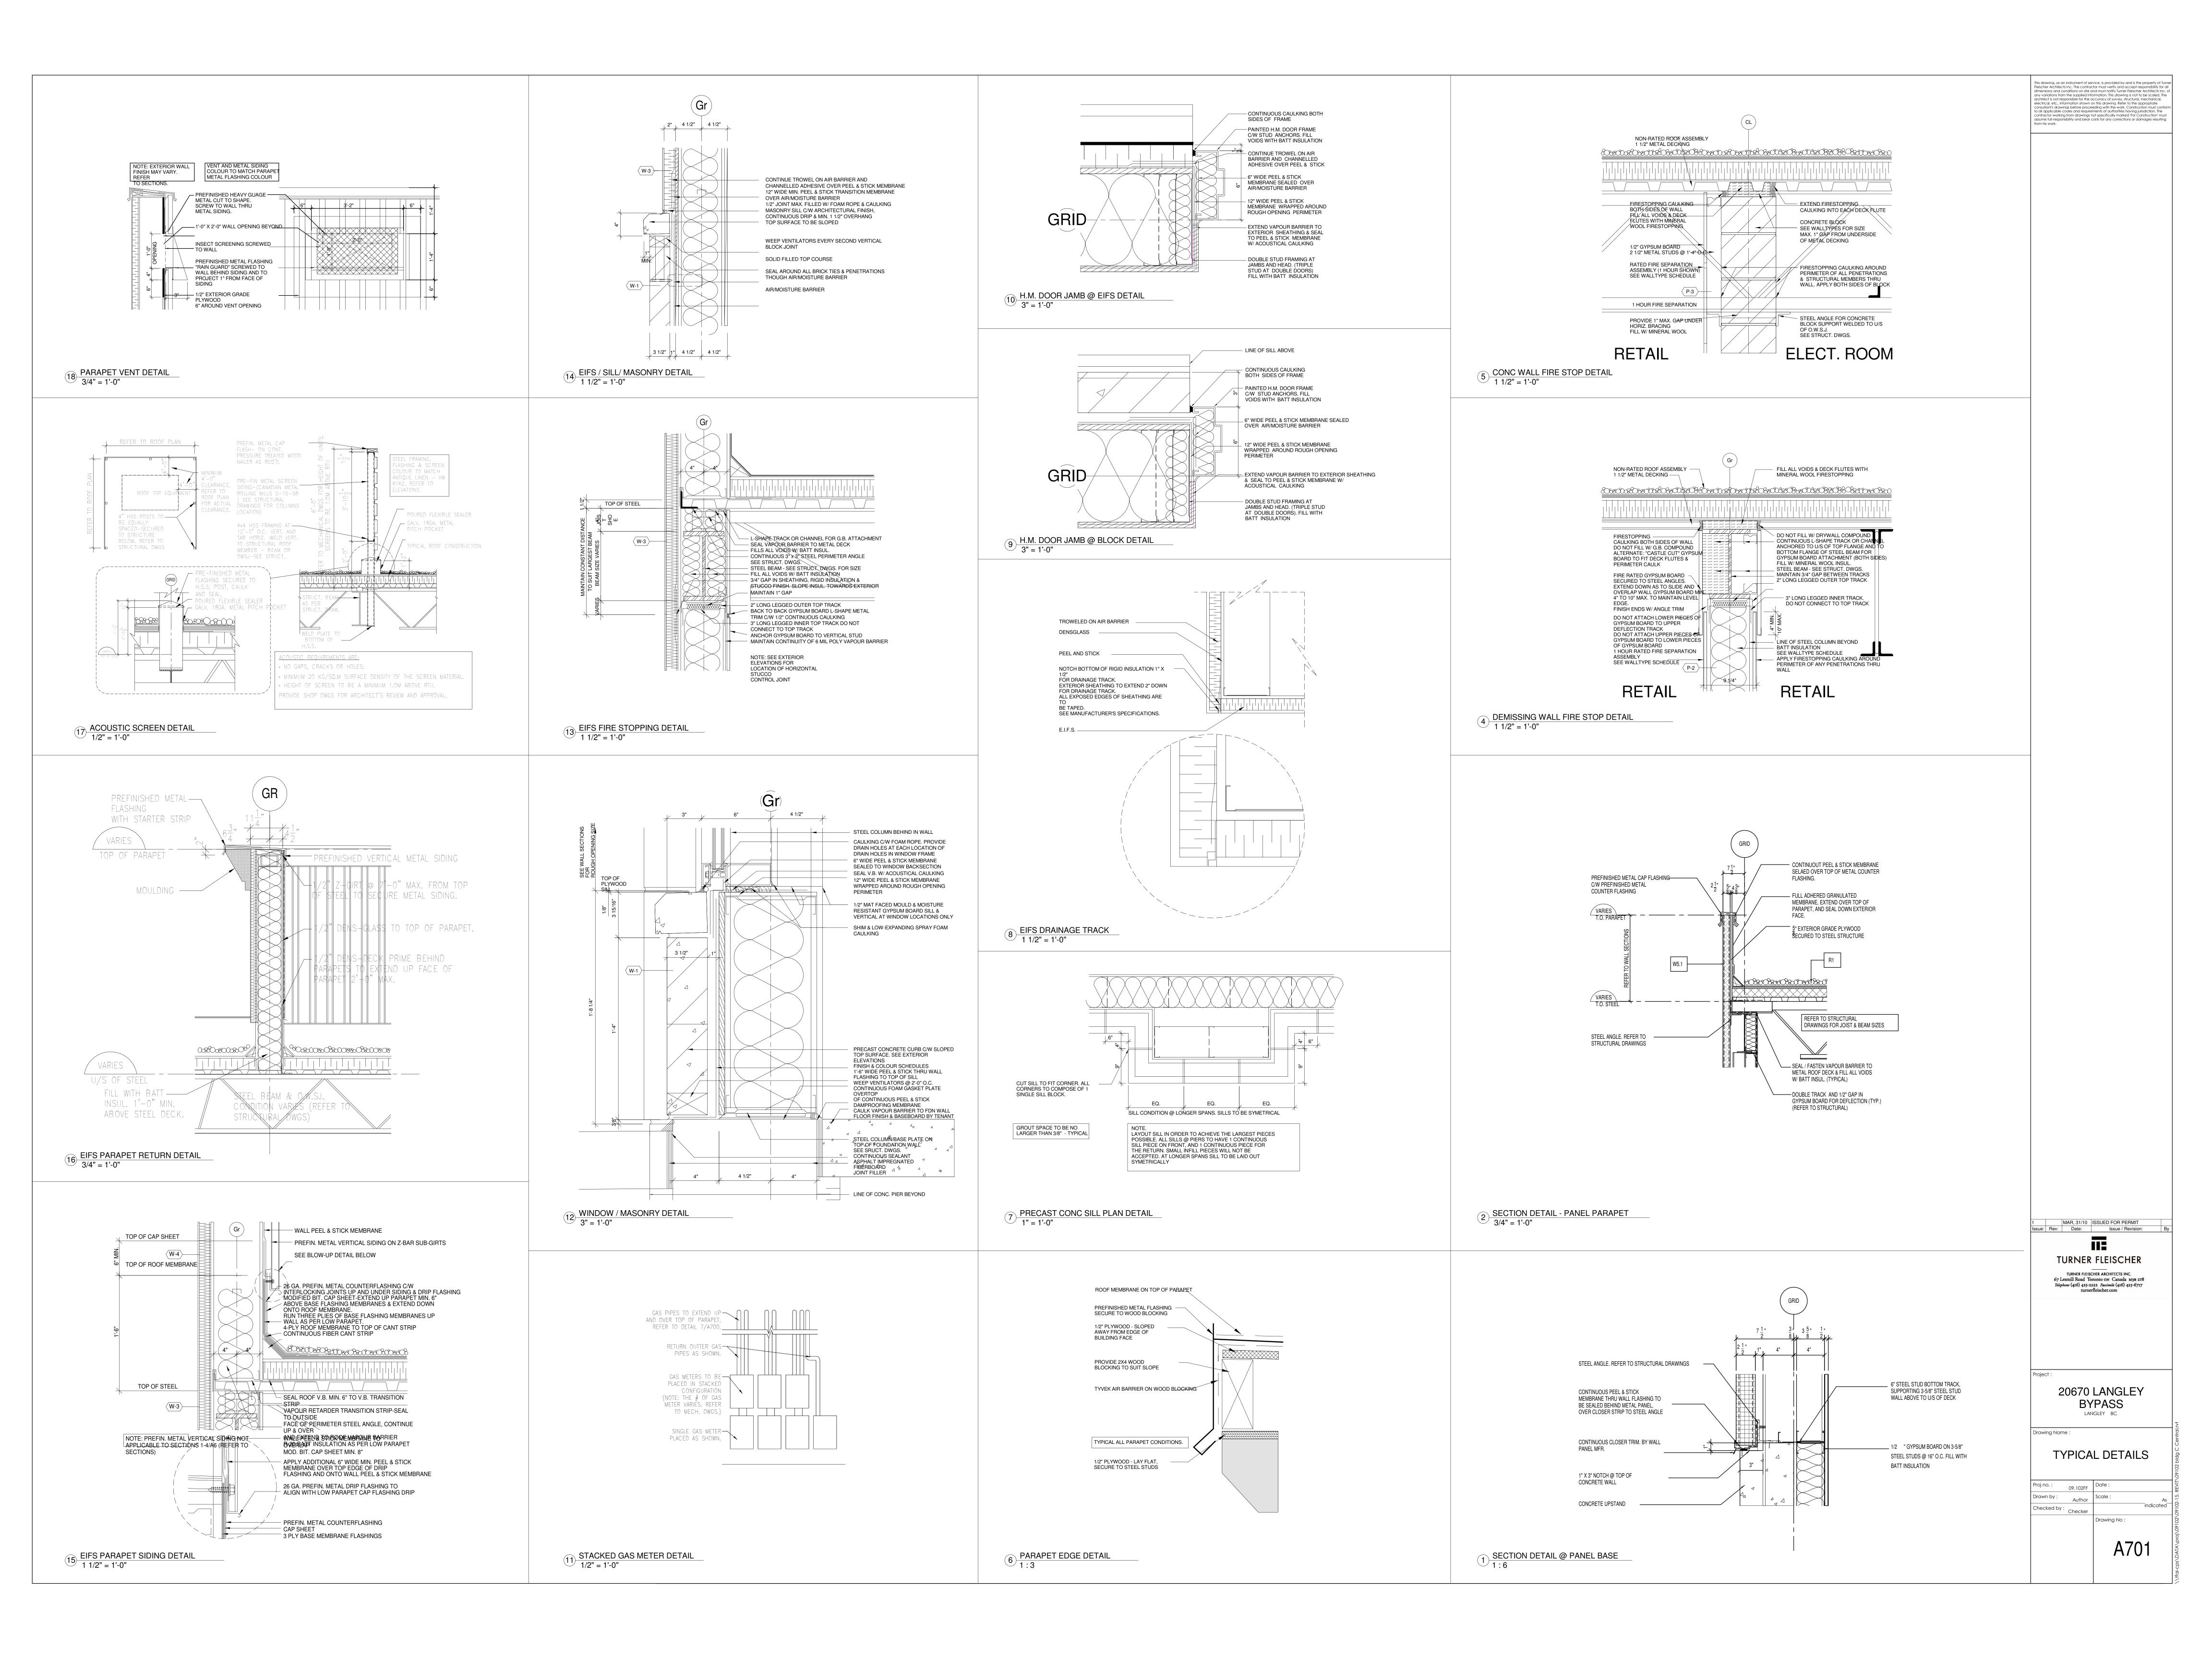







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WALL TYPE MARK	DESCRIPTION	DETAIL						
W1	BLOCK WALL CONSTRUCTION: - 3 5/8" ARCHITECTURAL STONE BLOCK VENEER C/W GALVANIZED BRICK TIES - 1" AIR SPACE (OR AS NOTED ON SECTIONS) - TROWELLED AIR BARRIER - 1/2" FIBERGLASS MATT FACED SILICONE TREATED GYPSUM BOARD - 8" STEEL STUDS @ 16" O.C TO BE DESIGNED &STAMPED BY AN ENGINEER - SUBMIT SHOP DRAWINGS - R-20 FIBER GLASS BATT INSULATION - 6 MIL POLY VAPOUR BARRIER. SEAL TO U/S OF ROOF DECK & BASE OF STUD @ FLOOR LEVEL - 1/2" GYPSUM BOARD	H 1 5/8" 4 1/2" 4 1/2" W1.1	BLOCK WALL CONSTRUCTION: - 3 5/8" ARCHITECTURAL STONE BLOCK VENEER C/W GALVANIZED BRICK TIES - 1" AIR SPACE (OR AS NOTED ON SECTIONS) - TROWELLED AIR BARRIER - 1/2" FIBERGLASS MATT FACED SILICONE TREATED GYPSUM BOARD - 6" STEEL STUDS @ 16" O.C TO BE DESIGNED & STAMPED BY AN ENGINEER - SUBMIT SHOP DRAWINGS - 6" AIR SPACE - 8" STEEL STUDS @ 16" O.C TO BE DESIGNED & STAMPED BY AN ENGINEER - SUBMIT SHOP DRAWINGS - R-20 FIBER GLASS BATT INSULATION - 6 MIL POLY VAPOUR BARRIER. SEAL TO U/S OF ROOF DECK & BASE OF STUD @ FLOOR LEVEL - 1/2" GYPSUM BOARD	2'-15/8" 4 1/2" 4 1/2" 4 1/2" 1/2" 1/						
W2	BRICK WALL CONSTRUCTION: NOT USE							
W3	EIFS WALL CONSTRUCTION: - ACRYLIC STUCCO FINISH, C/W MESH - 2" EXPANDED POLYSTYRENE INSULATION, C/W P.U.C.C. DRAINAGE SYSTEM - TROWELLED AIR BARRIER - 1/2" FIBERGLASS MATT FACED SILICONE TREATED GYPSUM BOARD - 8" STEEL STUDS @ 16" O.C TO BE DESIGNED & STAMPED BY AN ENGINEER - SUBMIT SHOP DRAWINGS - R-20 FIBER GLASS BATT INSULATION (TO FILL STUD SPACE) - 6 MIL POLY VAPOUR BARRIER. SEAL TO U/S OF ROOF DECK & BASE OF STUD @ FLOOR LEVEL - 1/2" GYPSUM BOARD	GRID						
W3.1	EIFS WALL CONSTRUCTION: - ACRYLIC STUCCO FINISH, C/W MESH - 2" EXPANDED POLYSTYRENE INSULATION, C/W P.U.C.C. DRAINAGE SYSTEM - TROWELLED AIR BARRIER - 1/2" FIBERGLASS MATT FACED SILICONE TREATED GYPSUM BOARD - 6" STEEL STUDS @ 16" O.C TO BE DESIGNED & STAMPED BY AN ENGINEER - SUBMIT SHOP DRAWINGS - 6" AIR SPACE - 8" STEEL STUDS @ 16" O.C TO BE DESIGNED & STAMPED BY AN ENGINEER - SUBMIT SHOP DRAWINGS - R-20 FIBER GLASS BATT INSULATION - 6 MIL POLY VAPOUR BARRIER. SEAL TO U/S OF ROOF DECK & BASE OF STUD @ FLOOR LEVEL - 1/2" GYPSUM BOARD	4111 GRID						
W4	CONC UPSTAND CONSTRUCTION: - 7" CONC UPSTAND - AIR SPACE - 3 5/ 8" STEEL STUDS @ 16" O.C FILL WITH FIBER GLASS BATT INSULATION - 6 MIL POLY VAPOUR BARRIER. SEAL TO U/S OF ROOF DECK & BASE OF STUD @ FLOOR LEVEL - 1/2" GYPSUM BOARD	GRID						
W5	WALL CONSTRUCTION - PREFINISHED INSULATED METAL PANEL SYSTEM C/W ALL APPLICABLE CONNECTION HARDWARE - 4-3/8" AIR SPACE - 8" STRUCTURAL STEEL GIRT (REFER TO STRUCTURAL DRAWINGS) - 3-5/8" STEEL STUDS @ 16" O.C. TO BE DESIGNED & STAMPED BY ENGINEER-SUBMIT SHOP DRAWINGS - 1/2" GYPSUM BOARD	3.58" 4.3/8"						
W6	EIFS WALL CONSTRUCTION: - ACRYLIC STUCCO FINISH, C/W MESH - 2" EXPANDED POLYSTYRENE INSULATION, C/W P.U.C.C. DRAINAGE SYSTEM - TROWELLED AIR BARRIER - 1/2" FIBERGLASS MATT FACED SILICONE TREATED GYPSUM BOARD - 8" STEEL STUDS @ 16" O.C TO BE DESIGNED & STAMPED BY AN ENGINEER - SUBMIT SHOP DRAWINGS - R-20 FIBER GLASS BATT INSULATION (TO FILL STUD SPACE) - 1/2" FIBERGLASS MAT FACED SILICONE TREATED GYPSUM BOARD (DENSE DECK PRIME TO BE APPLIED TO 2'-0" ABOVE T.O.S.) - ICE & WATER SHIELD - 3/4" Z-GIRTS @ 7'-0" O.C. MAX - 1 1/2" VERTICAL METAL SIDING	GRID						
W7	PARAPET / EIFS WALL CONSTRUCTION: - ACRYLIC STUCCO FINISH, C/W MESH - 2" EXPANDED POLYSTYRENE INSULATION, C/W P.U.C.C. DRAINAGE SYSTEM - TROWELLED AIR BARRIER - 1/2" FIBERGLASS MATT FACED SILICONE TREATED GYPSUM BOARD - 8" STEEL STUDS @ 16" O.C TO BE DESIGNED & STAMPED BY AN ENGINEER - SUBMIT SHOP DRAWINGS - R-20 FIBER GLASS BATT INSULATION (TO FILL STUD SPACE) - 6 MIL POLY VAPOUR BARRIER. SEAL TO U/S OF ROOF DECK & BASE OF STUD @ FLOOR LEVEL - 1/2" FIBERGLASS MAT FACED SILICONE TREATED GYPSUM BOARD (DENSE DECK PRIME TO BE APPLIED TO 2'-0" ABOVE T.O.S.) - FULLY ROOF MEMBRANE	GRID						
W8	WALL CONSTRUCTION - PREFINISHED INSULATED METAL PANEL SYSTEM C/W ALL APPLICABLE CONNECTION HARDWARE - 5-3/8" AIR SPACE - 8" STRUCTURAL STEEL GIRT (REFER TO STRUCTURAL DRAWINGS) - 3-5/8" STEEL STUDS @ 16" O.C. TO BE DESIGNED & STAMPED BY ENGINEER-SUBMIT SHOP DRAWINGS - 1/2" GYPSUM BOARD	REFER TO FLOOR PLAN FOR 1 HR & 2 HR FRR WALL LOCATION						

WALL TYPE MARK	DESCRIPTION	DETAIL
P1	WALL CONSTRUCTION: ULC W-407 (1 HOUR FIRE RATING) - 5/8" FIRE RATED GYPSUM BOARD TO U/S OF DECK - 8" STEEL STUDS @ 16" O.C FILL WITH BATT INSULATION - 5/8" FIRE RATED GYPSUM BOARD TO U/S OF DECK NOTE: PROIVIDE CONTINUOUS SMOKE/FIRE SEAL @ TOP OF GYPSUM BOARD / U/S OF DECK. GYPSYM BOARD TO FOLLOW PROFILE OF DECK FLUTES DESCRIPTION IS FOR REFERENCE ONLY. REFER TO ULC MANUAL.	
P2	WALL CONSTRUCTION: (2 HOUR FIRE RATING) - 6" CONCRETE BLOCK TO U/S OF STRUCTURE - 2 1/2" STEEL STUDS @ 16" 0.C. - FILL WITH BATT INSULATION - 1/2" GYPSUM BOARD TO U/S OF STRUCTURE NOTE: PROIVIDE CONTINUOUS SMOKE/FIRE SEAL @ TOP OF CONCRETE BLOCK WALL @ ROOF DECK FLUTES REFER TO OBC SB-2 TABLE 2.1.1	
ROOF TYPE S	SCHEDULE	
ROOF TYPE MARK	DESCRIPTION	DETAIL
R1	ROOF CONSTRUCTION: - 2 PLY SBS ROOF MEMBRANE - R-20 RIGID INSULATION - 6 MILL POLY VAPOUR BARRIER - 1/2" GYPSUM BOARD - 1 1/2" METAL ROOF DECK (REFER TO STRUCTURAL) - ROOF JOIST (REFER TO STRUCTURAL) PROVIDE NON-SLIP PAVERS FROM ROOF HATCH TO AROUND ALL HVAC UNITS, AND EXHAUST FANS	

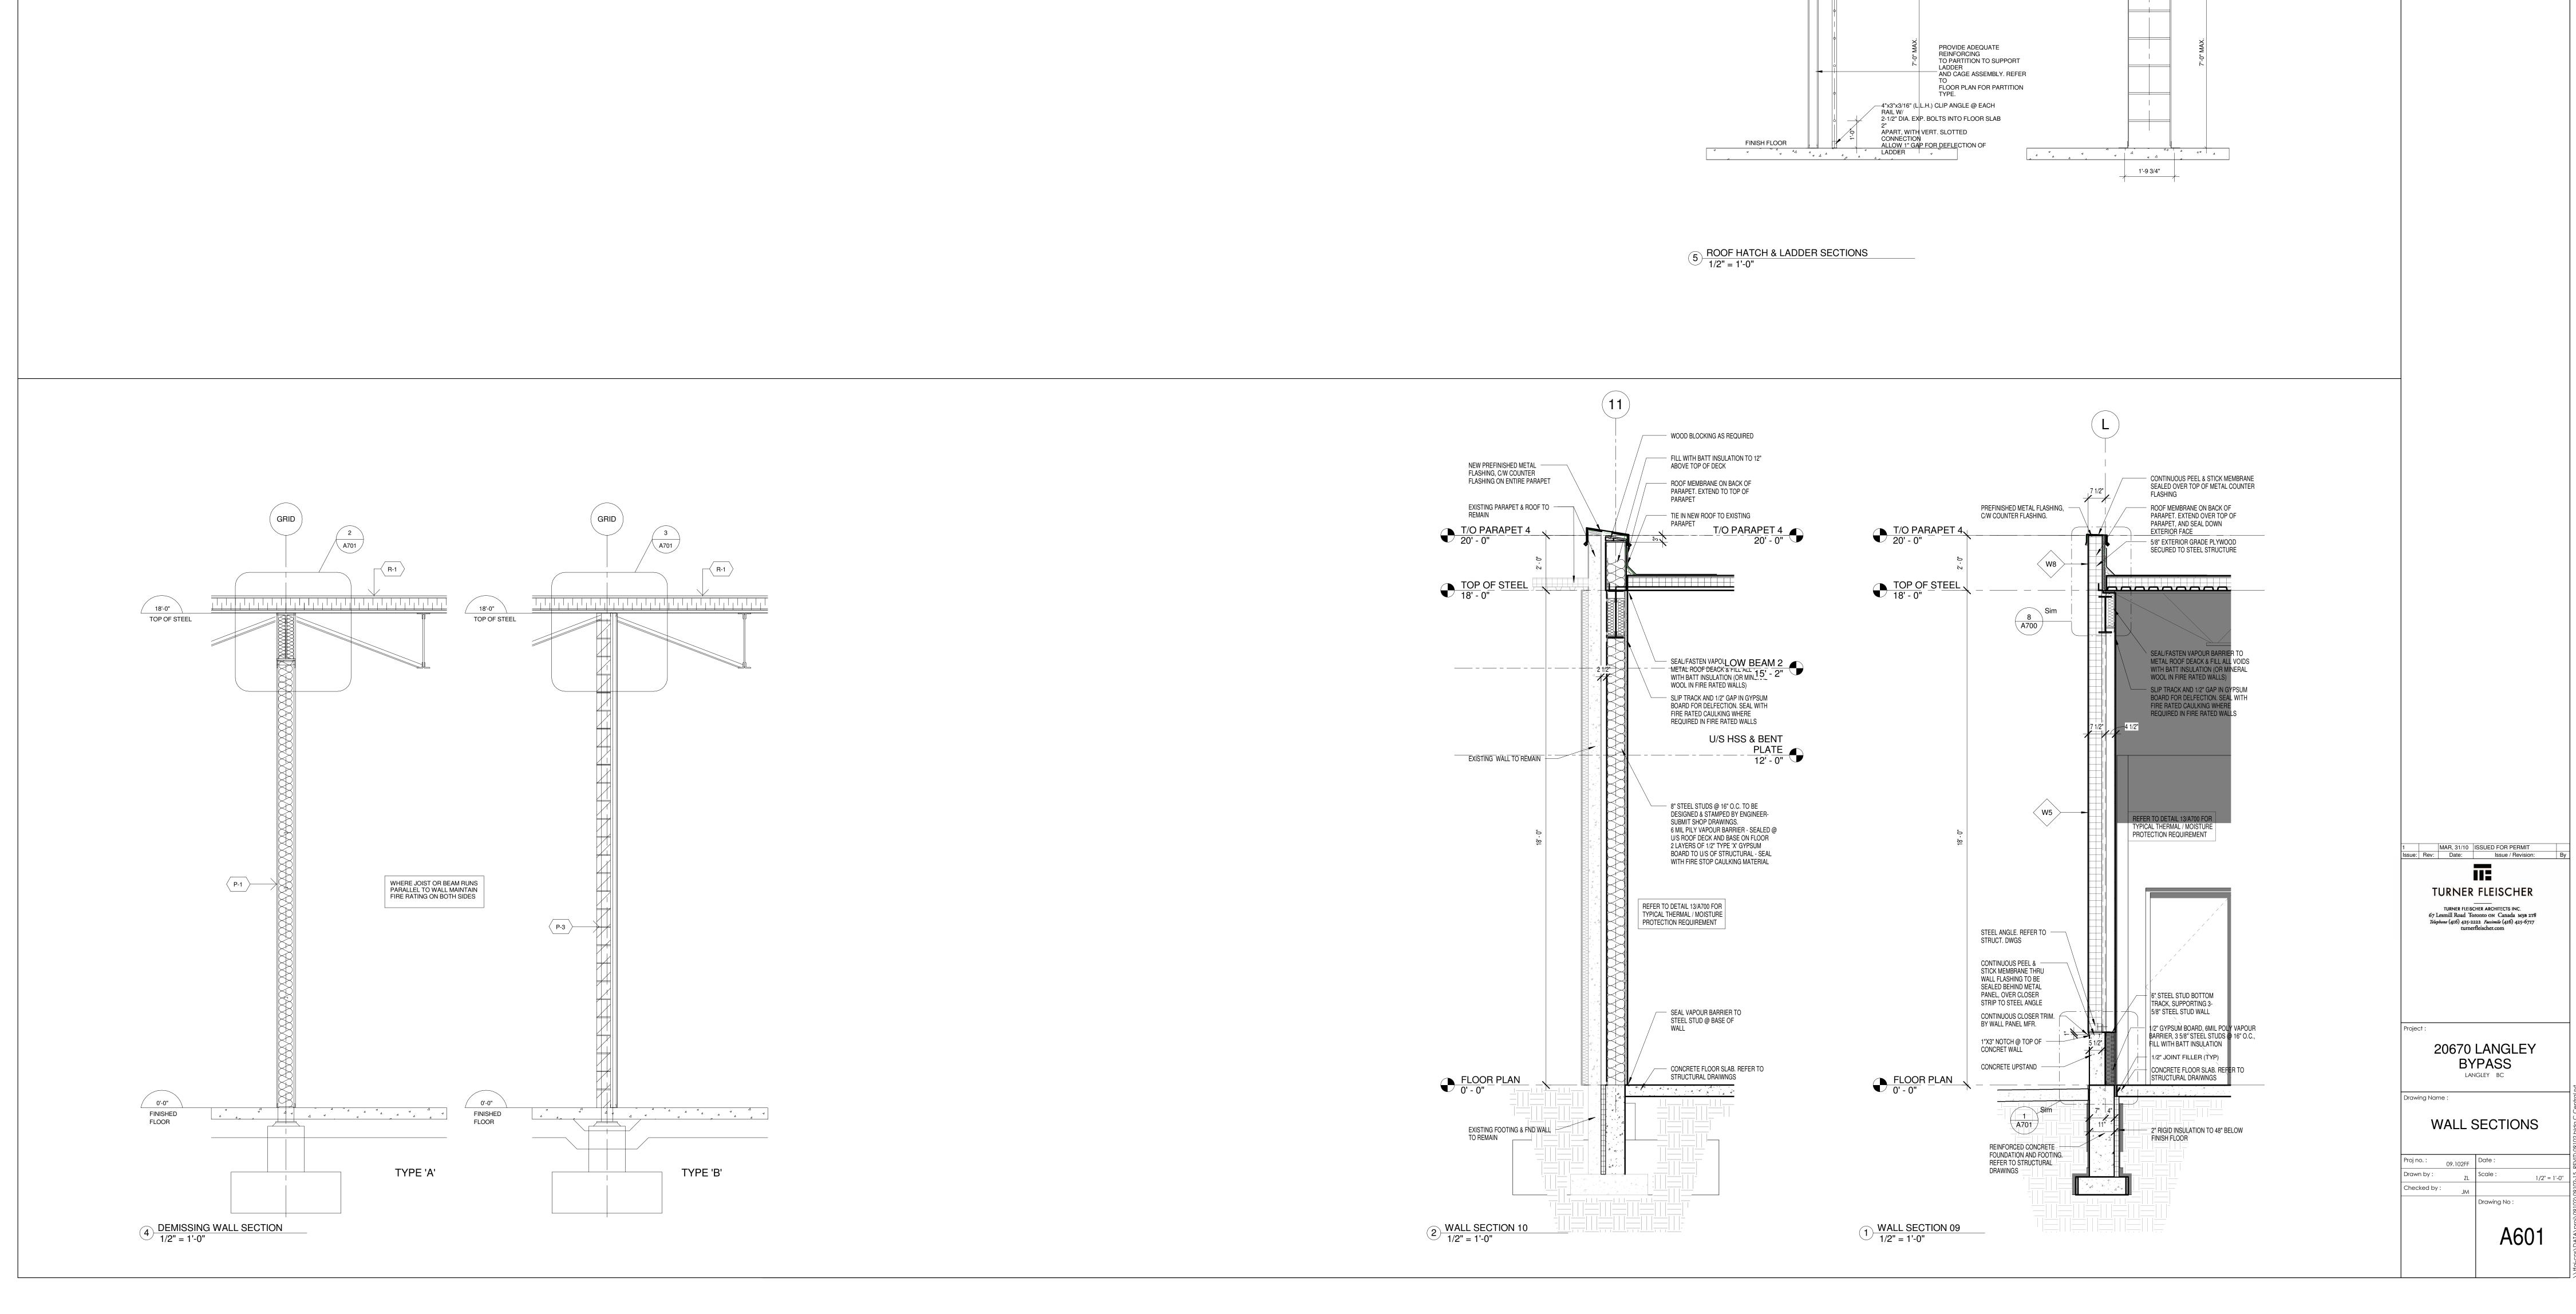REFER TO FLOOR PLAN FOR LOCATION OF 1 HR & 2 HR FIRE RATED WALL ULC W407 - 1 HR FRR: REFER TO ULC MANUAL FOR SPECIFIC COMPOSITION AND CONSTRUCTION METHOD. ULC W404 - 2 HR FRR: REFER TO ULC MANUAL FOR SPECIFIC COMPOSITION AND CONSTRUCTION METHOD. GENERAL CONSTRUCTION NOTES: (APPLICABLE TO ALL ARCH DRAWIINGS)

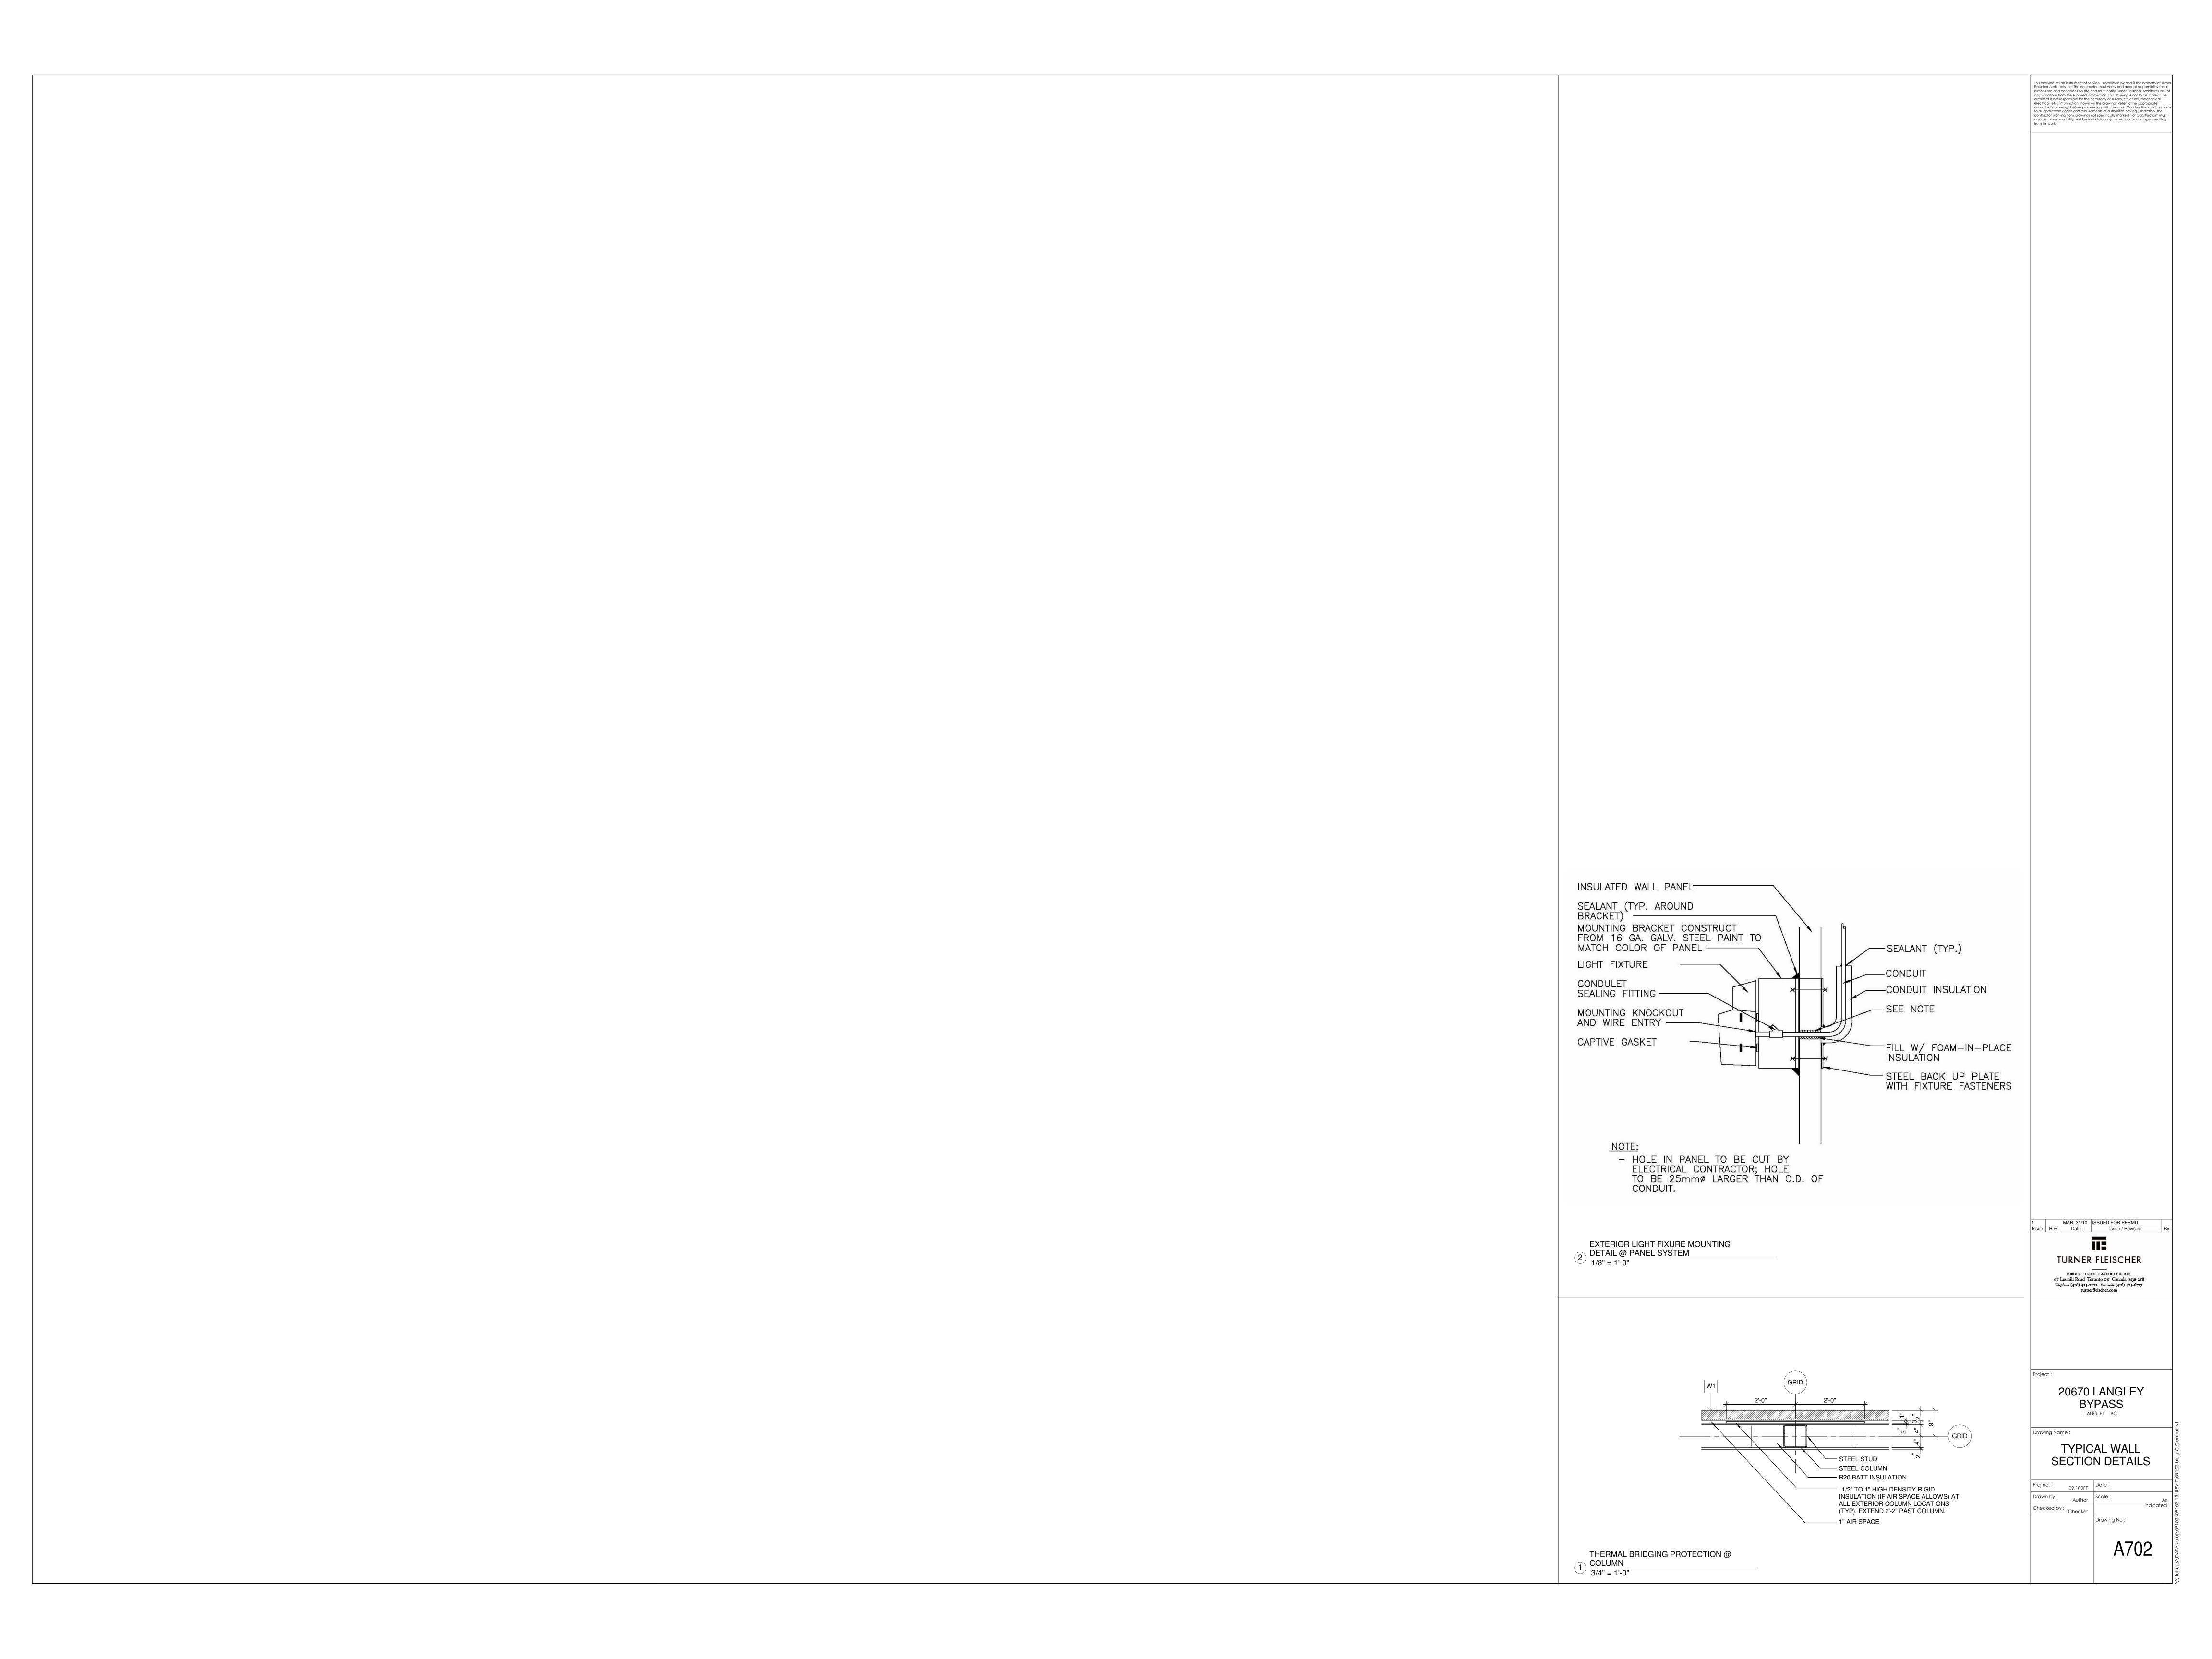1. ALL STEEL STUDS TO BE DESIGNED & STAMPED BY PROFESSIONAL ENGINEER LICENSED IN ONTARIO-SUBMIT SHOP DRAWINGS

2. ALL INTERIOR CONC. BLOCK WALLS HEIGHT TO UNDERSIDE OF METAL ROOF DECK UNLESS NOTED OTHERWISE. IF JOIST OR BEAM CONFLICT, CONSTRUCT FIRE RATED WALL TO U/S OF DECK AS PER DEMISING WALL CONSTRUCTION.

3. CONCRETE FLOORS TO BE SMOOTH & LEVEL WIH A MAXIMUM DEVIATION OF 1/2" IN 20 FEET. READY TO ACCEPT TENANT'S FLOOR FINISH MATERIAL. UNLESS NOTED OTHERWISE ON FLOOR PLAN OR

SPECIFICATION - TO COMPLY WITH TENANT REQUIREMENTS. 4. GYPSUM BOARD WALLS TO BE TAPED, SANDED & PRIMED, READY TO ACCEPT TENANT'S FINISH UNLESS NOTED OTHERWISE. GYPSUM BOARD TO EXTEND TO UNDERSIDE OF METAL ROOF DECK UNLESS NOTED OTHERWISE. GYPSUM BOARD PIERS OR BUMPS EXTENDING INTO TENANT SPACE WILL NOT BE ACCEPTABLE.

5. ALL INTERIOR STEEL COLUMNS TO BE LEFT EXPOSED & UNFINISHED UNLESS NOTED OTHERWISE. 6. EXTERIOR GLAZING UNITS TO BE OF CLEAR ANODIZED FINISH, FIXED HERMETICALLY SEALED DOUBLE GLAZED THERMALLY INSULATED GLASS IN PREFINISHED, THERMALLY BROKEN ALUMINUM FRAME.

7. SEE DOOR SCHEDULE FOR DOOR & FRAME TYPE, SIZE & HARDWARE REQUIREMENTS.

8. METAL ROOF DECK CEILING TO BE SUITABLE FOR PAINT WITHOUT ADDITIONAL PREPARATION BY TENANT. 9. ROUGH-IN OF WASHROOM FIXTURES TO BE BY GENERAL CONTRACTOR & LOCATION TO SUIT FINAL TENANT LAYOUT TO FOLLOW. EACH TENANT TO OBTAIN SEPARATE PERMIT FOR ALL INTERIOR WORK.

10. H.V.A.C. BY GENERAL CONTRACTOR & TO SUIT FINAL TENANT LAYOUT TO FOLLOW. WHERE APPLICABLE

12. SHOP QUALITY SPRINKLER DRAWINGS COMPLETE WITH HYDRAULIC CALCULATIONS TO BE SUBMITTED TO THE CITY UNDER SEPARATE COVER BY THE SUCCESSFUL CONTRACTOR'S SPRINKLER SYSTEM DESIGN

ENGINEER (WHERE SPRINKLERS ARE REQUIRED). 13. ALL DEMISING WALLS TO MAINTAIN A CONTINUOUS FIRE SEPARATION @ U/S OF ROOF DECK.

11. TENANT TO OBTAIN A SEPARATE PERMIT REGARDING EXTERIOR SIGNAGE.

14. RETURN BLOCK, BRICK AND EIFS AT ALL WINDOW AND DOOR OPENINGS 1/2" MAXIMUM PAST FRAME.

15. ALL R.W.L. TO BE TIGHT TO BACK OF COLUMN.

16. REFER TO STRUCTURAL DRAWINGS FOR ALL SUPPORT CONDITIONS AND STEEL STUD CONSTRUCTION REQUIREMENTS.

17. 2'-0" HIGH 1/2" DENS DECK PRIME BEHIND PARAPETS, 2'-0" ABOVE TOP OF DECK CONTINUE WITH 1/2" DENS GLASS BEHIND PARAPETS TO TOP OF PARAPET. APPLICABLE IF PLYWOOD IS NOT USED

18 2" METAL STRAPS @ 24" O.C. AT ALL DOUBLE WALL CONSTRUCTION TO SECURE BATT INSULATION IN PLACE.

19. NO STRUCTURAL MEMBER TO BE WIDER THAN 8". ALL STRUCTURAL MEMBERS TO FIT WITHIN WALLS.

20. PIPING, TUBING, DUCTS, CHIMNEYS, OPTICAL FIBRE CABLES, ELECTRICAL WIRES AND CABLES, TOTALLY ENCLOSED NON-COMBUSTIBLE RACEWAYS, ELECTRICAL OUTLETS BOXES AND OTHER SIMILAR BUILDING SERVICES THAT PENETRATE A MEMBRANE FORMING PART OF AN ASSEMBLY REQUIRED TO HAVE A FIRE-RESISTANCE RATING, OR A FIRE SEPARATION, SHALL BE SEALED BY A FIRE STOP SYSTEM.

21. AT ALL TRANSITITIONS OF MATERIALS ie: EIFS, BRICK, BLOCK & SIDING, JOINTS TO BE CAULKED. 22. WRAP ENTIRE PERIMETER OF ROUGH OPENINGS WITH PEEL AND STICK BEFORE INSTALLATION OF WINDOW FRAMES. TYPICAL FOR ALL DOORS AND WINDOWS.

23. PROVIDE 1/2" EXTERIOR GRADE PLYWOOD @ ALL SIGNAGE, AWNINGS, LIGHT FIXTURE LOCATIONS AND, GAS PIPES UNLESS OTHERWISE NOTED.

24. ALL EXPOSED FOUNDATION WALLS TO BE SANDBLASTED

25. GAS PIPES TO BE PAINTED SAME COLOUR AS WALL ON WHICH THEY ARE MOUNTED, W/ YELLOW STRIPES SPACED @ 4'-0" FROM EACH OTHER.

26. GENERAL CONTRACTOR TO ENSURE THAT FIRE RATING OF DEMISING WALLS IS NOT ALTERED FROM THE DESIGNATED WALL CONSTRUCTION LISTED.

27. WHERE FIRE RATED WALL RUNS PERPENDICULAR TO METAL DECK, DRYWALL TO FOLLOW DECK CONTOUR C/W 1/2" TO 3/4" GAP. FILL VOIDS WITH FIRE STOP MINERAL WOOL AND FIRE STOP CAULKING/SPRAY TO MAINTAIN WALL FIRE RATING.

28. HORIZONTAL JOINT @ DEFLECTION TRACK CAULKING TO MAINTAIN FIRE RATING (TYPICAL).

29. VERTICAL DRYWALL CONTROL JOINT TO BE @ EVERY COLUMN SEE SPECIFICATIONS (TYPICAL).

30. PROVIDE STUCCO FINISH ON BACK SIDE OF MOULDING AT ALL PARAPET RETURNS, AND MOULDING TERMINATIONS.

31. SEAL ALL BRICK TIE PENETRATION @ DENSE GLASS WITH BAKOR ADHESIVE.

32. 1'-0" OF BATT INSULATION WITHIN PARAPETS ABOVE STEEL DECK.

33. PROVIDE BRICK TIES LENGTHS APPLICABLE FOR AIR SPACES. PROVIDE HEAVY DUTY BRICK TIES WHERE AIR SPACE IS WIDER THAN 1". REFER TO SECTIONS AND PLAN DETAILS FOR AIR SPACE REQUIREMENTS.

34. PAINT EXTERIOR H.M. DOOR EDGES.

35. GRADES SHOWN ON FLOOR PLANS, ELEVATIONS, AND SECTIONS DATUM TAGS ARE FOR REFERENCE ONLY. CONTRACTOR IS TO CONFIRM AND COORDINATE ALL GRADES WITH GRADING PLAN

ROLL UP DOOR

2 GENERAL NOTES 12" = 1'-0"

								Door Schedule				
		Location		Size		Door		Frame				
Door Number	From	Wall Fire Rating od	Fire Rating	Door Type Width	Height	Thickness	Material	Finish	Material	Finish	Hardware	Comments
LOC	OR PLAN											
01	UNIT C1	EXTERIOR		6' - 0"	6' - 11 7/8"		ALUM	ANODIZED	ALUM	ANODIZED	3,10,11, 13, 14,18	THUMB TURN CANNOT ROTATE MORE THAN 90 DEGREE INANY DIRECTION PROVIDE WIDE THROW HINGES
02	UNIT C2	EXTERIOR		6' - 0"	6' - 11 7/8"		ALUM	ANODIZED	ALUM	ANODIZED	3,10,11, 13, 14,18	THUMB TURN CANNOT ROTATE MORE THAN 90 DEGREE INANY DIRECTION PROVIDE WIDE THROW HINGES
03	UNIT C3	EXTERIOR		6' - 0"	6' - 11 7/8"		ALUM	ANODIZED	ALUM	ANODIZED	3,10,11, 13, 14,18	THUMB TURN CANNOT ROTATE MORE THAN 90 DEGREE INANY DIRECTION PROVIDE WIDE THROW HINGES
	UNIT C4	EXTERIOR		6' - 0"	6' - 11 7/8"		ALUM	ANODIZED	ALUM	ANODIZED	3,10,11, 13, 14,18	THUMB TURN CANNOT ROTATE MORE THAN 90 DEGREE INANY DIRECTION PROVIDE WIDE THROW HINGES
05	EXTERIOR	UNIT C1		3' - 0"	7' - 0"	0' - 1 3/4"	INSUL HM	PAINTED	STEEL	PAINTED	2,5,6,10,11,18,23	BLANK EXTERIOR FACE
06	EXTERIOR	UNIT C4		B 3' - 0"	7' - 0"	0' - 1 3/4"	INSUL HM	PAINTED	STEEL	PAINTED	2,5,6,10,11,18,23	BLANK EXTERIOR FACE
07	UNIT C3	EXTERIOR		3' - 0"	7' - 0"	0' - 1 3/4"	INSUL HM	PAINTED	STEEL	PAINTED	2,5,6,10,11,18,23	BLANK EXTERIOR FACE
80	UNIT C2	EXTERIOR		3' - 0"	7' - 0"	0' - 1 3/4"	INSUL HM	PAINTED	STEEL	PAINTED	2,5,6,10,11,18,23	BLANK EXTERIOR FACE
09	UNIT C1	EXTERIOR		3' - 0"	7' - 0"	0' - 1 3/4"	INSUL HM	PAINTED	STEEL	PAINTED	2,5,6,10,11,18,23	BLANK EXTERIOR FACE
10	C5	EXTERIOR		3' - 0"	7' - 0"	0' - 1 3/4"	INSUL HM	PAINTED	STEEL	PAINTED	2,5,6,10,11,18,23	BLANK EXTERIOR FACE
11		EXTERIOR		8' - 0"	8' - 0"		GLASS	PAINTED	STEEL	PAINTED		SEE MFR SPEC, GALSS OVERHEAD DOOR
12	UNIT C4	EXTERIOR		3' - 0"	7' - 0"	0' - 1 3/4"						
14		UNIT C4		3' - 0"	7' - 0"	0' - 1 3/4"						
15		UNIT C4		3' - 0"	7' - 0"	0' - 1 3/4"						
16		UNIT C3		3' - 0"	7' - 0"	0' - 1 3/4"						
17		UNIT C3		3' - 0"	7' - 0"	0' - 1 3/4"						
18		UNIT C2		3' - 0"	7' - 0"	0' - 1 3/4"						
19		UNIT C2		3' - 0"	7' - 0"	0' - 1 3/4"						
20	UNIT C1			3' - 0"	7' - 0"	0' - 1 3/4"						
21		UNIT C1		3' - 0"	7' - 0"	0' - 1 3/4"						

HA	RDWARE	1				
ТЕМ NO.	DESCRIPTION	ITEM NO.	DESCRIPTION			
1	FLUSH BOLTS, TOP AND BOTTOM	13	AUTOMATIC OPERATOR			
2	LOCKSET	14	KEYED THUMBTURN			
3	PASSAGE SET (H.C. REQ'TS FOR W.C.)	15	THUMBTURN ONLY			
4	CLOSET SET	16	AS SUPPLIED BY MFGR.			
5	PANIC HARDWARE	17	DETEX ALARM			
6	CLOSER - SURFACE MOUNTED, HEAVY DUTY	18	DOOR SWEEP			
7	PUSH/PULL	19	DOCK SEAL			
8	KICKPLATE	20	MOTORIZED OPERATION			
9	PICTOGRAM W/R SIGN	21	PEEP HOLE			
10	THRESHOLD	22	H.C. OPENER	TYPE A	TYPE B	TYPE C
11	WEATHERSTRIP			ALUMINUM	EXTERIOR	EXTERIOR
12	ELECTRIC OPERATOR			ENTRANCE ANODIZED	INSULATED	INSULATED
					HOLLOW METAL	ROLL UP DOC

1 DOOR SCHEDULE 1/2" = 1'-0"

 1
 MAR, 31/10
 ISSUED FOR PERMIT

 Issue:
 Rev:
 Date:
 Issue / Revision:
 TURNER FLEISCHER TURNER FLEISCHER ARCHITECTS INC.
67 Lesmill Road Toronto on Canada M3B 2T8
Telephone (416) 425-2222 Facsimile (416) 425-6717
turnerfleischer.com

20670 LANGLEY

DOOR SCHEDULE & **GENERAL NOTES**

Drawing No :

WALL TYPES

1" = 1'-0"

EXTERIOR WALL TYPE SCHEDULE